SOFTBALL FIELDHOUSE PACE HIGH SCHOOL

NORRIS RD.

PACE, FL 32565

FOR THE SCHOOL BOARD OF SANTA ROSA COUNTY

PHASE II DOCUMENTS

OWNER CONTACTS: ARCHITECT: STRUCTURAL: DAG Architects, Inc. Berube-Leonard, LLC Santa Rosa County School Board 40 South Palafox Place, Suite 201 Santa Rosa County, FL 3101 N. 12th Ave Phone: 850-983-5123 Pensacola, Florida 32502 Suite 102 Phone: 850-429-9004 Pensacola, FL 32503 Fax: 850-983-5115 Fax: 850-429-9005 Phone: 850-473-9955 Ext 3 Fax: 850-473-1770 Joseph B. Harrell Assistant Superintendent for PIC: Dave Luttrell, AIA Administrative Services PIC: Stephen W Leonard, PE PM: Owen Gipson, AIA Email: ogipson@dagarchitects.com Email: steve@blse.net Harrelj@mail.santarosa.k12.fl.us **ELECTRICAL**: **TELECOMMUNICATIONS: CIVIL & SURVEYING:** Schmidt Consulting Group, Inc. Schmidt Consulting Group, Inc. Jehle-Halstead, Inc. 901 West Garden Street 901 West Garden Street 5414 Highway 90 Pensacola, FL 32502 Pensacola, FL 32502 Milton, FL 32571 Phone: 850-438-0050 Phone: 850-994-9503 Phone: 850-438-0050 Fax: 850-432-8631 Fax: 850-432-8631 Fax: 850-994-9504 Patrick Jehle, Jr. E.I. Todd Nicholson, PE Todd Nicholson, PE Email: toddn@schmidtconsulting Email: toddn@schmidtconsulting Email: pjehle@jehle-halstead.com group.com group.com PLUMBING: MECHANICAL: Schmidt Consulting Group, Inc. Schmidt Consulting Group, Inc. 901 West Garden Street 901 West Garden Street Pensacola, FL 32502 Pensacola, FL 32502 Phone: 850-438-0050 Phone: 850-438-0050 Fax: 850-432-8631 Fax: 850-432-8631 Joe Jones Joe Jones Email: joe@schmidtconsulting Email: joe@schmidtconsulting group.com group.com

Project Teams and Discipline

Allocation

A1

SCALE: NTS

Florida Building Code (FBC) 2017 Sixth Edition - Referenced Below, Unless Noted NFPA Life Safety Code - 2014 Edition National Electric Code County Codes

e. City Codes

FLORIDA BUILDING CODE: OCCUPANCY: GROUP E

CONSTRUCTION: TYPE IIB, UNSPRINKLERED,

EXPOSURE: B **IMPORTANCE FACTOR WIND: 1** WIND SPEED: 160 MPH TYPE OF CONSTRUCTION: IIB RISK CATEGORY: III OCCUPANCY: GROUP E EDUCATIONAL OCCUPANT LOAD: 49 SQUARE FOOTAGE: 2450 SF +/-EGRESS CALCULATIONS: SEE LS101

FLORIDA PRODUCT APPROVAL NUMBERS

A3

SCALE: NTS

PRODUCT MANUFACTURER	ITEM	APPROVAL TYPE	APPROVAL NUMBER
STEELCRAFT H-SERIES	EXTERIOR HOLLOW METAL DOORS	STATE	FL-12400
BERRIDGE	STANDING SEAM METAL ROOFING	STATE	FL-11159.3
WINCO	WINDOWS - SLIDERS 3410	STATE	FL-2266.1 (impact)

Building Code Data

PROJECT INDEX:

GENERAL:

SET COVER SHEET - PROJECT STATS, SHEET INDEX, DESIGN TEAM

CIVIL SHEETS: C000 - NOTES AND INFORMATION **C001 - EXISTING SITE CONDITIONS** C002 - SITE DEMOLITION PLAN C003 - SITE IMPROVEMENTS PLAN C004 - SITE DIMENSIONING PLAN C005 - SITE GRADING PLAN C006 - SITE STORMWATER PLAN C007 - SITE UTILITY PLAN C008 - SITE CONSTRUCTION DETAILS C009 - SITE EROSION CONTROL DETAILS C010 - SITE UTILITY DETAILS

STRUCTURAL SHEETS:

S001 - GENERAL NOTES AND TYPICAL DETAILS S101 - FOUNDATION PLAN, SECTIONS AND DETAILS S102 - ROOF FRAMING PLAN, TYPICAL JOIST AND DECK DETAILS S201 - SECTIONS AND DETAILS

Project Sheet Index

ARCHITECTURAL SHEETS:

LIFE SAFETY PLAN ARCHITECTURAL SITE PLAN FLOOR PLAN DIMENSION PLAN REFLECTED CEILING PLAN **ROOF PLAN** EXTERIOR ELEVATIONS

BUILDING SECTIONS DOOR, FRAME, AND WINDOW SCHEDULE

INTERIOR ELEVATIONS

SCALE: NTS

P001 - PLUMBING LEGEND P002 - PLUMBING LEGEND P101 - SANITARY & VENT PLAN P201 - DOMESTIC WATER PLAN

P301 - RISER DIAGRAMS P401 - PLUMBING DETAILS P402 - PLUMBING DETAILS

MECHANICAL:

M001 - MECHANICAL LEGEND M002 - MECHANICAL LEGEND M101 - MECHANICAL NEW WORK M201 - MECHANICAL DETAILS M202 - MECHANICAL DETAILS M301 - MECHANICAL CONTROLS

ELECTRICAL

E001 - ELECTRICAL LEGEND E201 - ELECTRICAL LIGHTING PLAN E202 - ELECTRICAL POWER PLAN E301 - ELECTRICAL DETAILS E302 - ELECTRICAL DETAILS E303 - ELECTRICAL DETAILS

DAG ARCHITECTS INC 40 S. PALAFOX PLACE - STE 201 PENSACOLA, FL 32502 TELEPHONE: 850-429-9004 FAX: 850-429-9005

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PROJECT LOCATION PACE HIGH SCHOOL 4065 NORRIS RD PACE, FL 32571	DN:	Α
A4	Vicinity Map	1

Drawn By: SJT Checked By: DAG

Revision


11-01-18 Project No 18045

Drawing Title:

Set Cover Sheet -

Project Stats, Code Review, Sheet Index & Design Team

A-000

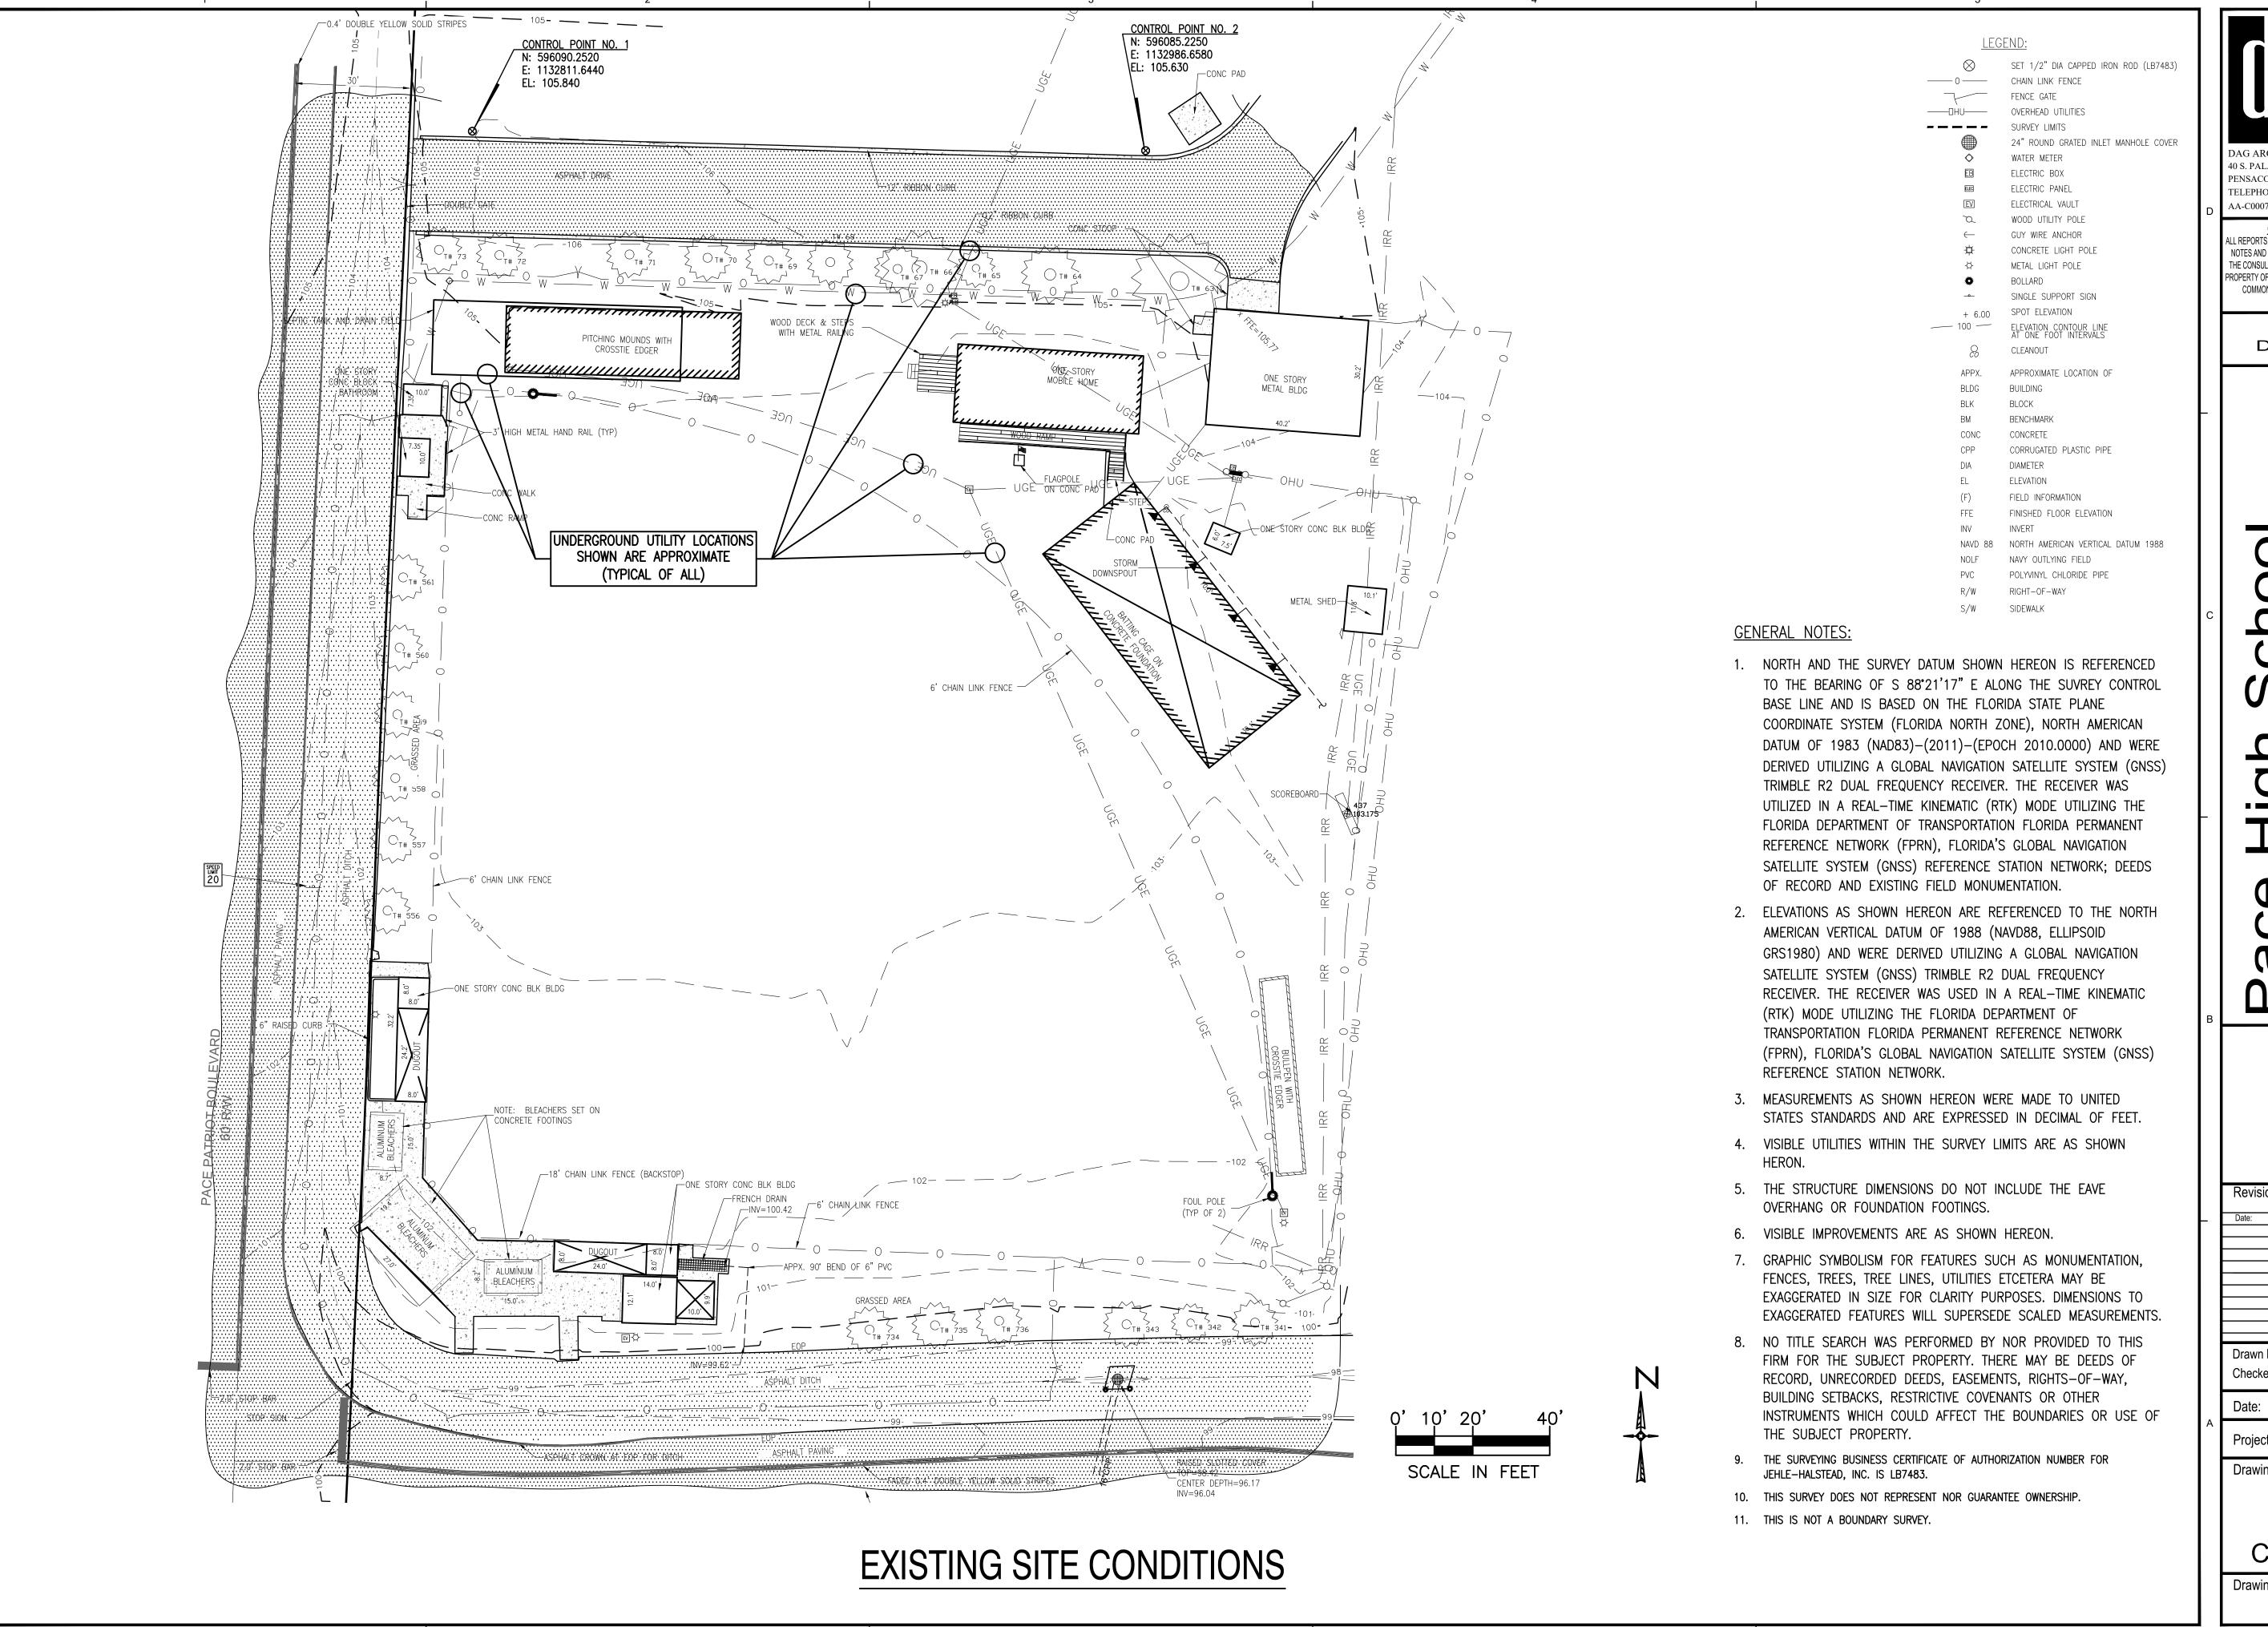



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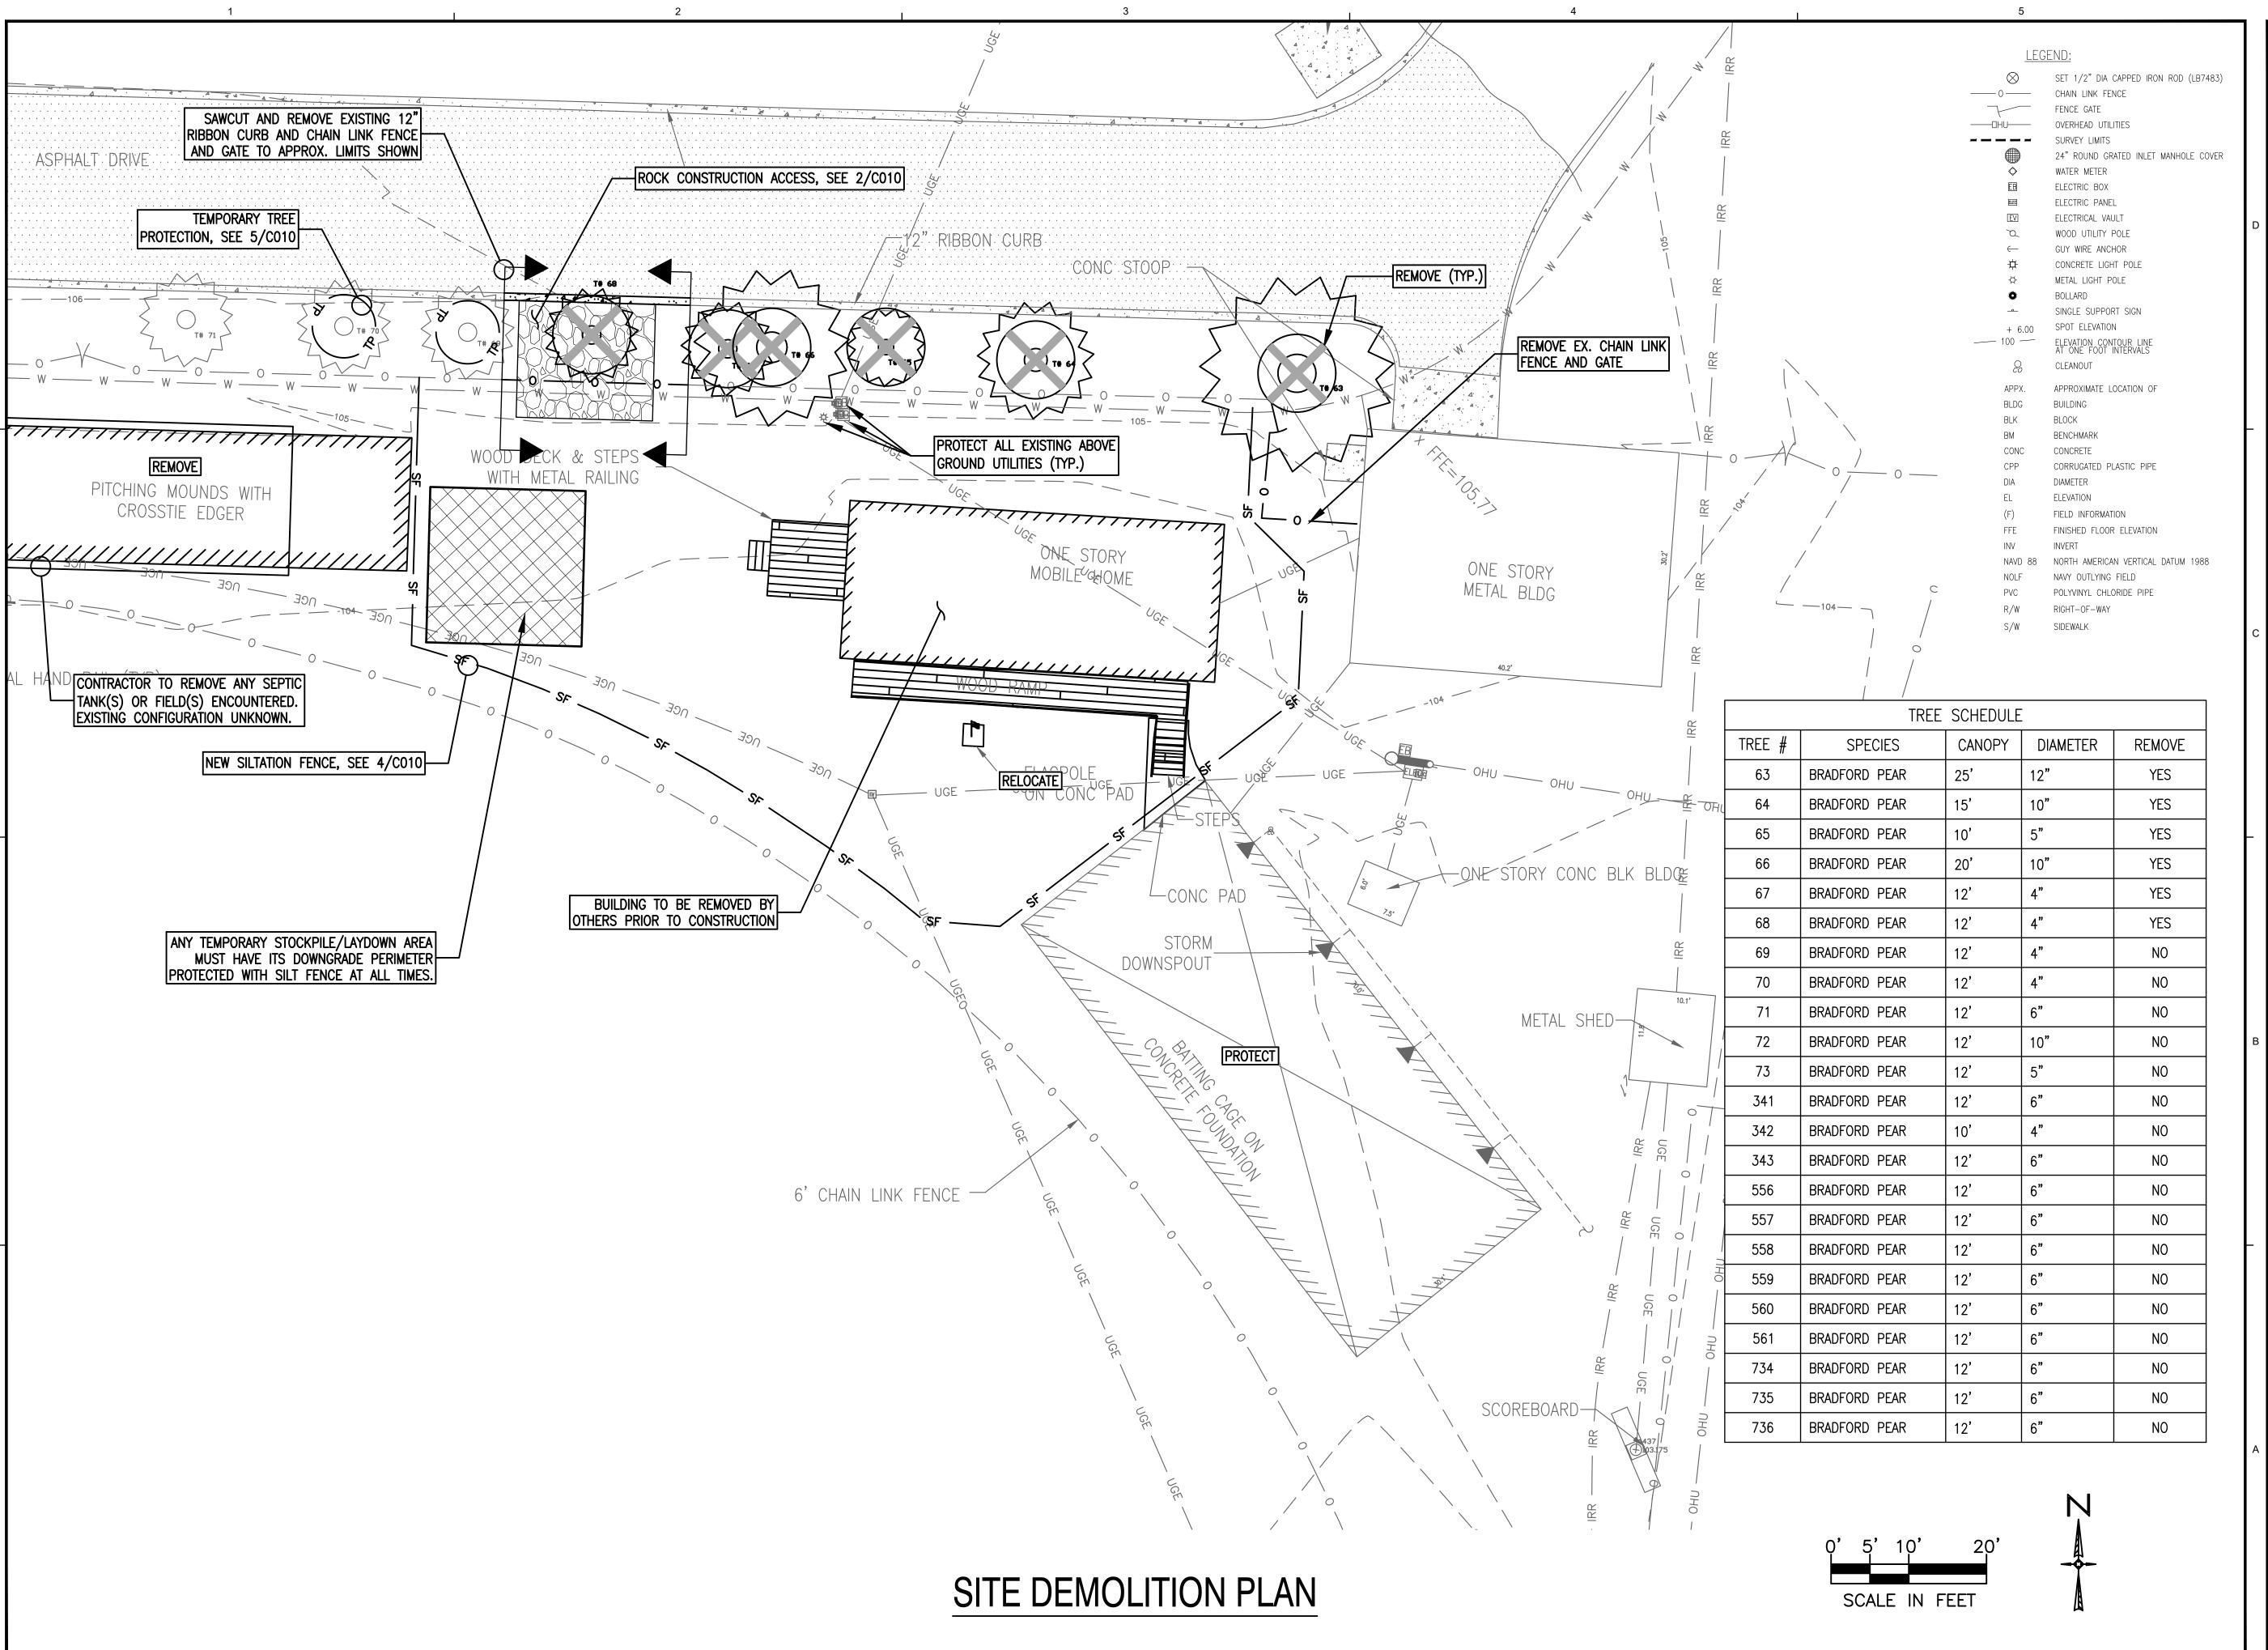
Date: 11-01-18

Project No.: 180040

Drawing Title:

EXISTING SITE CONDITIONS

Drawing No.: C001





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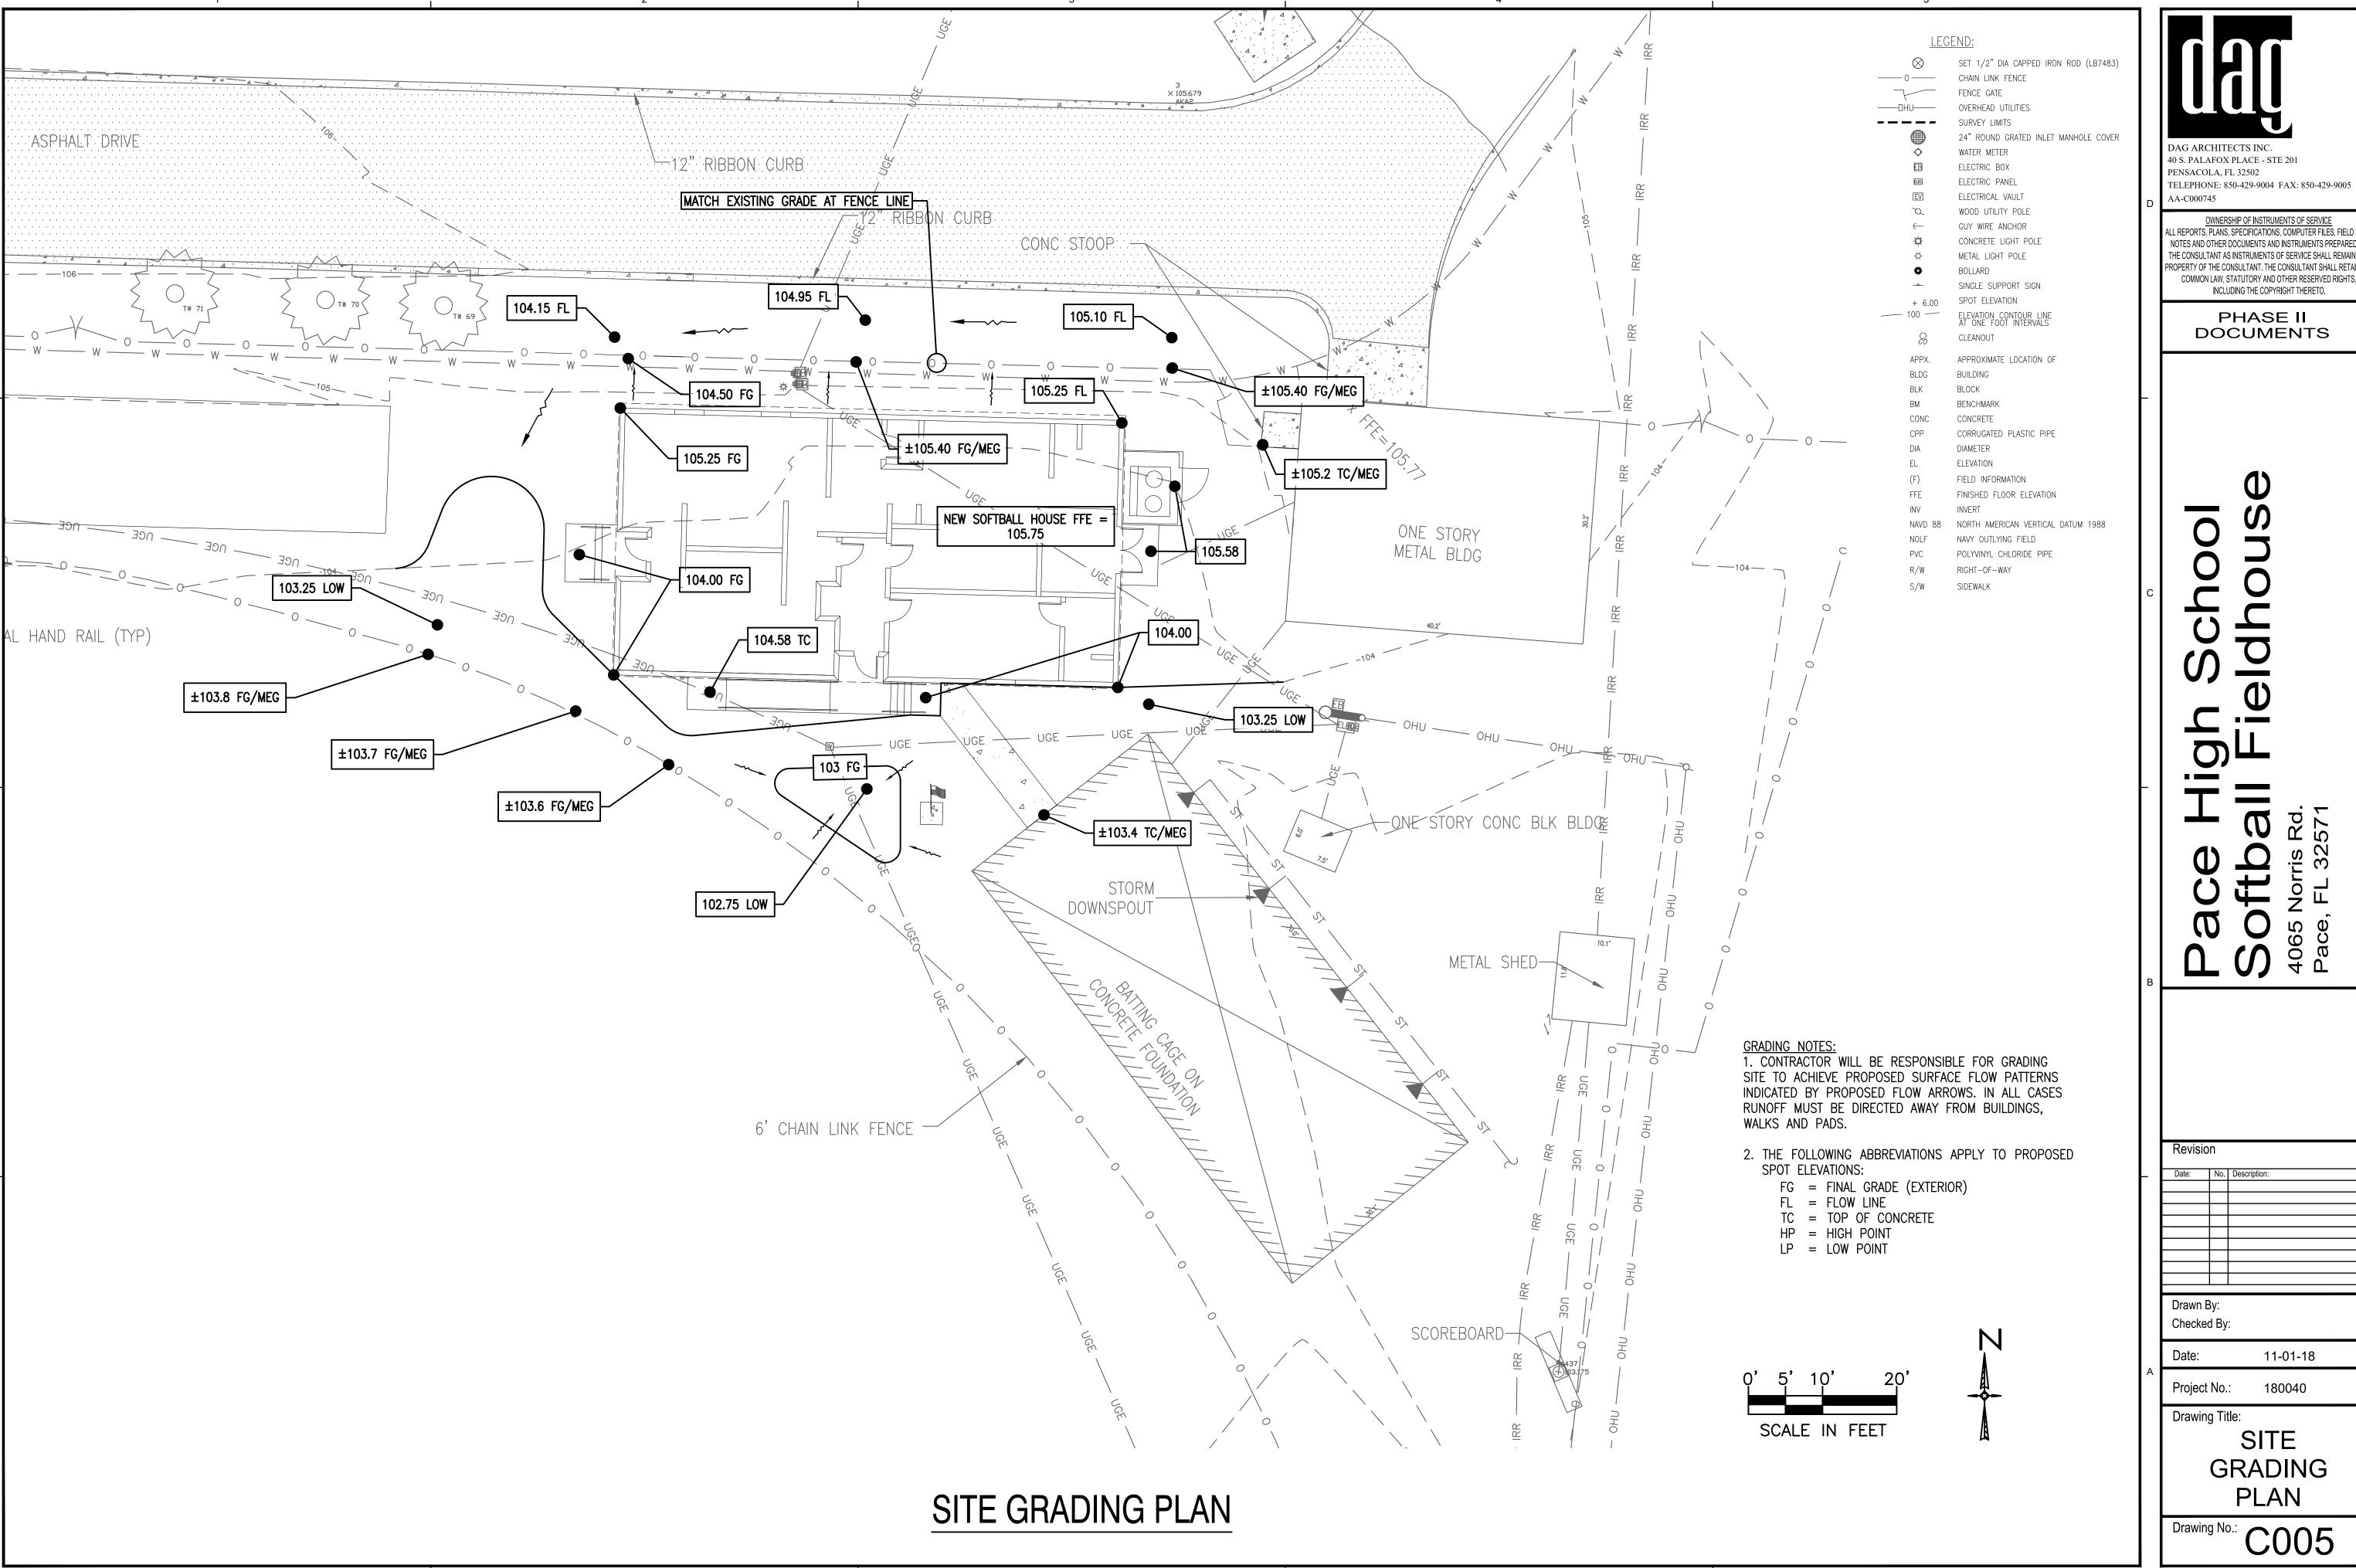
rate: 11-01-18

ect No.: 180040

Drawing Title:

SITE DEMOLITION PLAN


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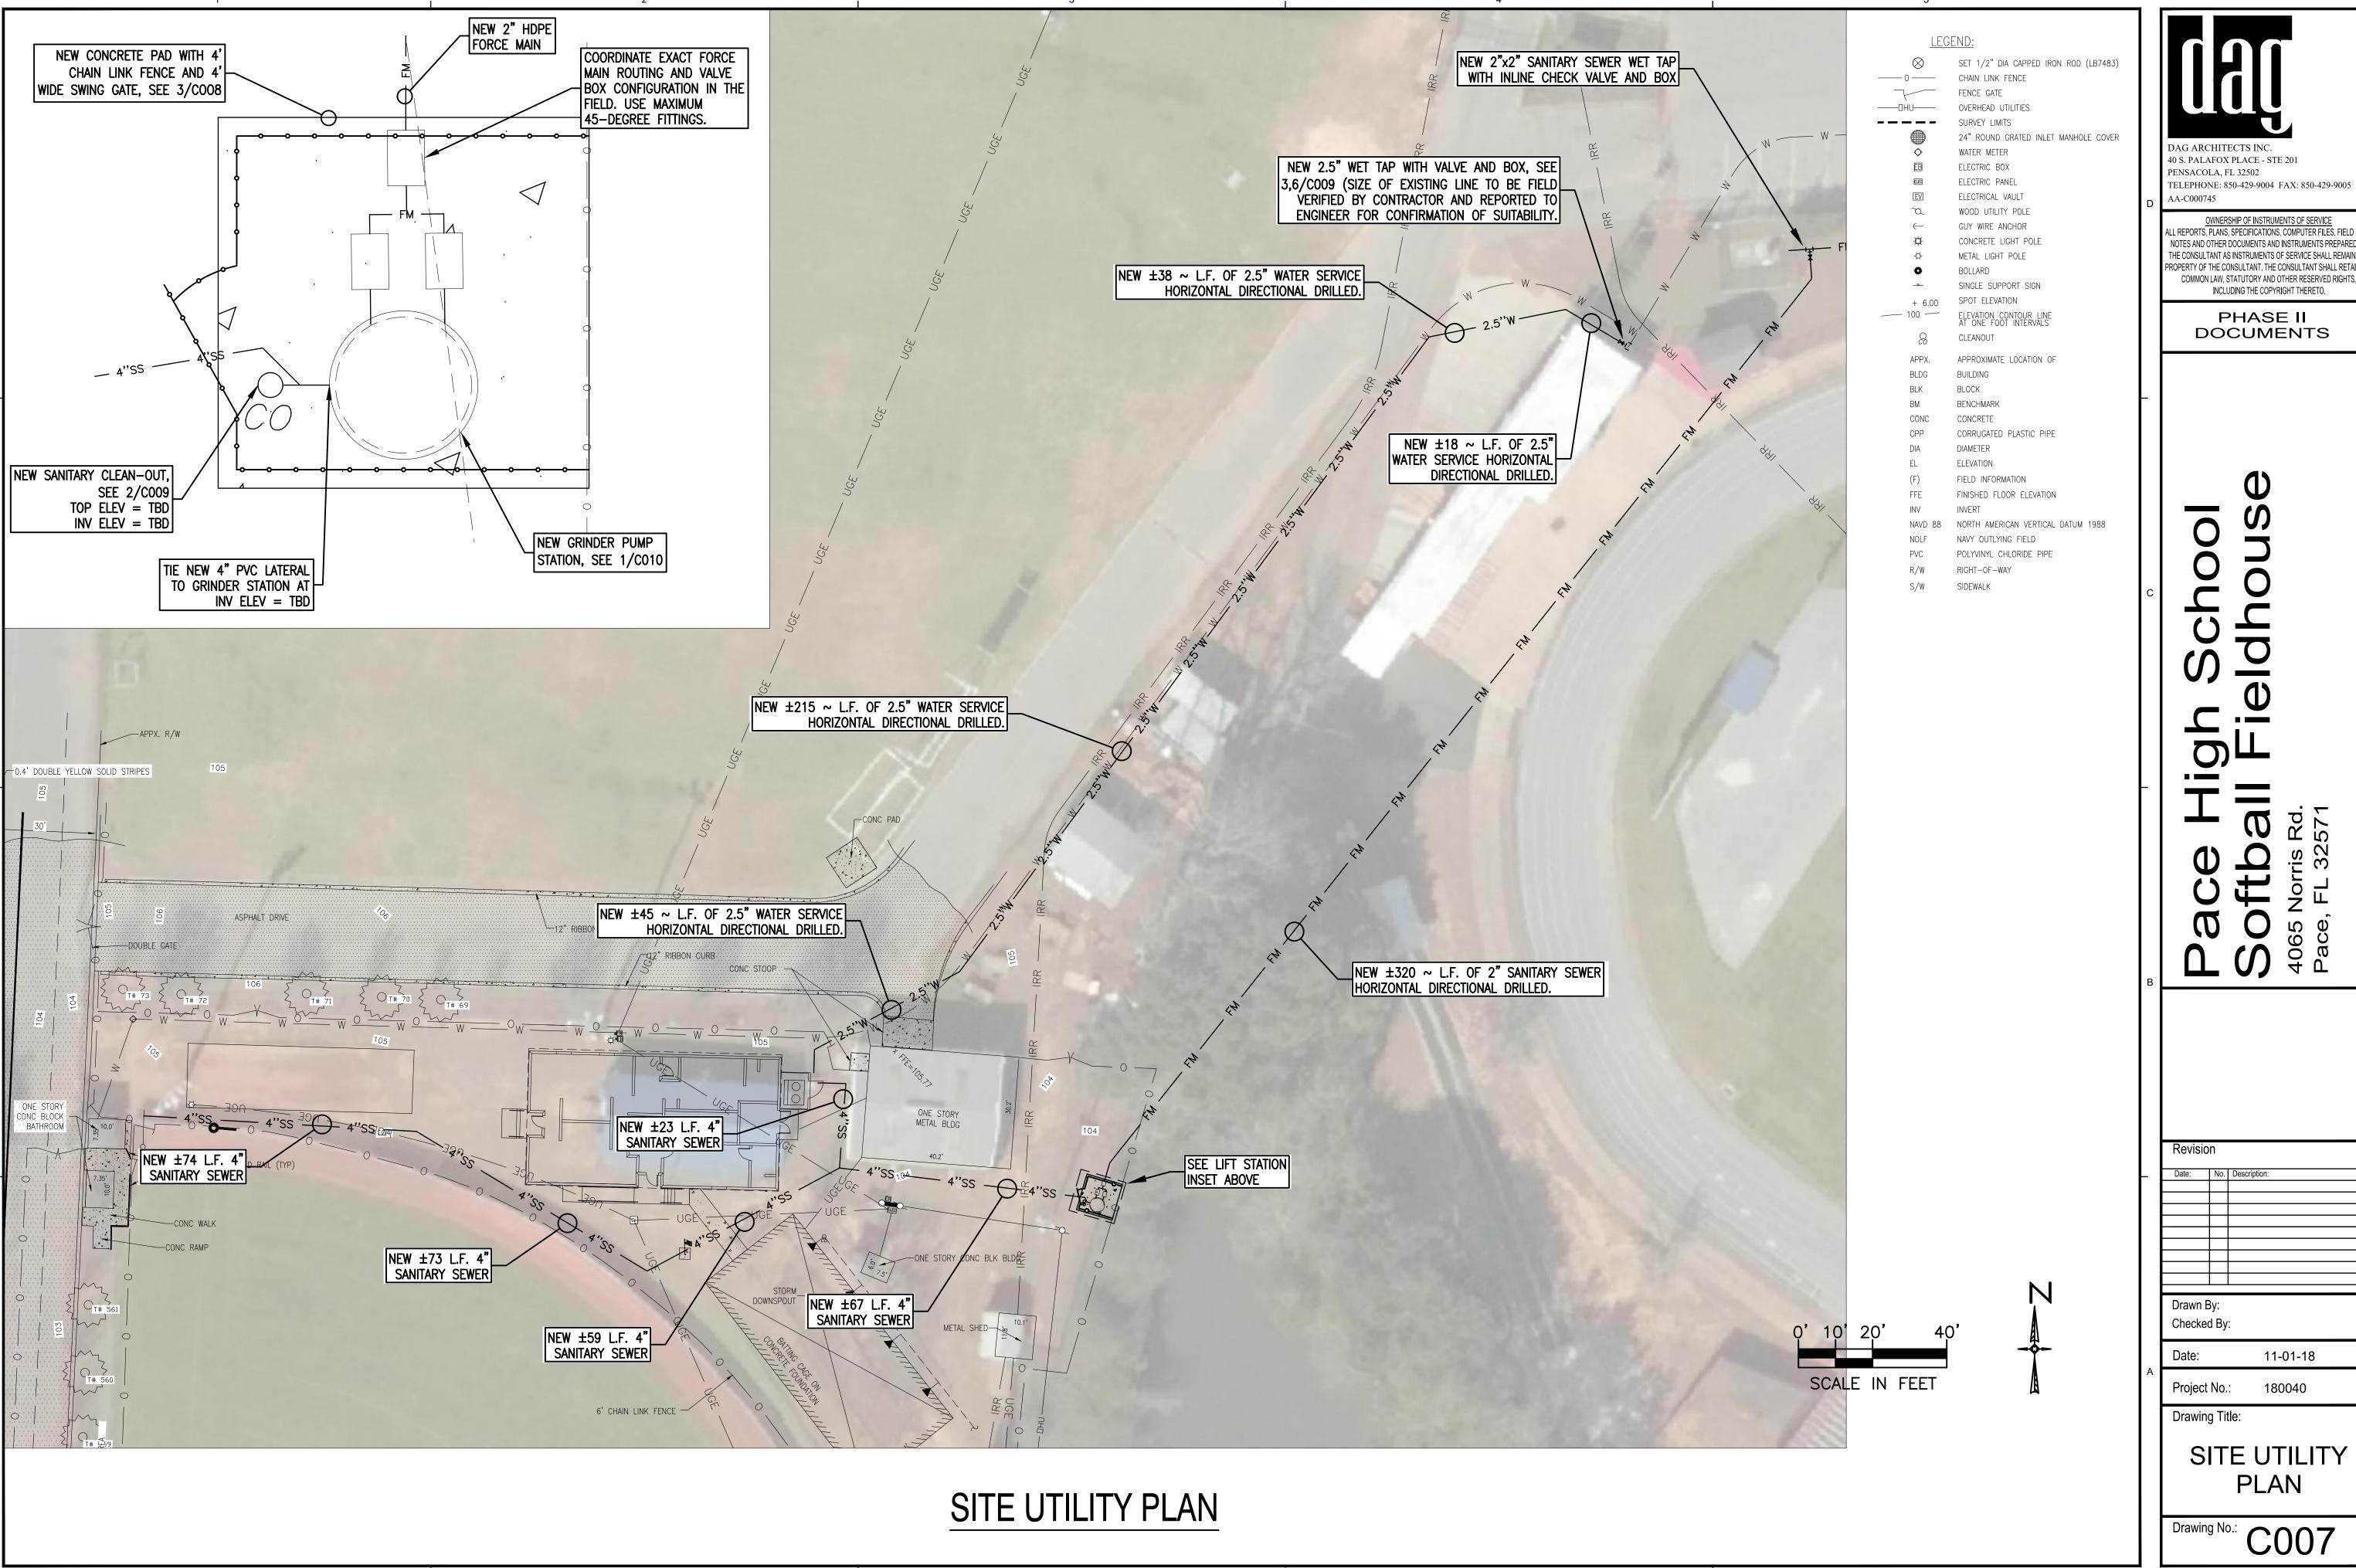


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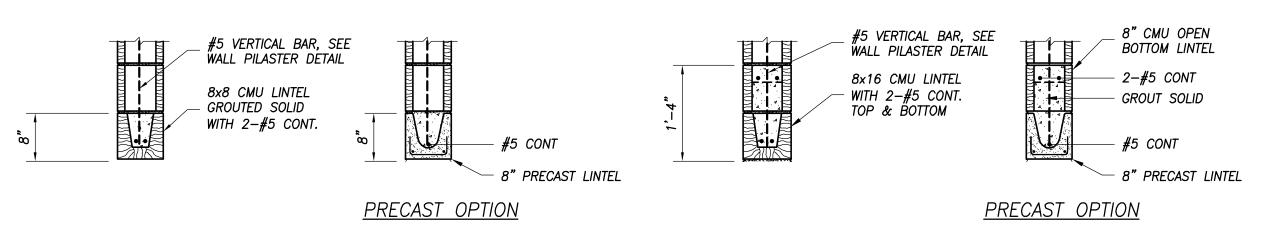
GRADING






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<u>OPENINGS TO 4'-0"</u>

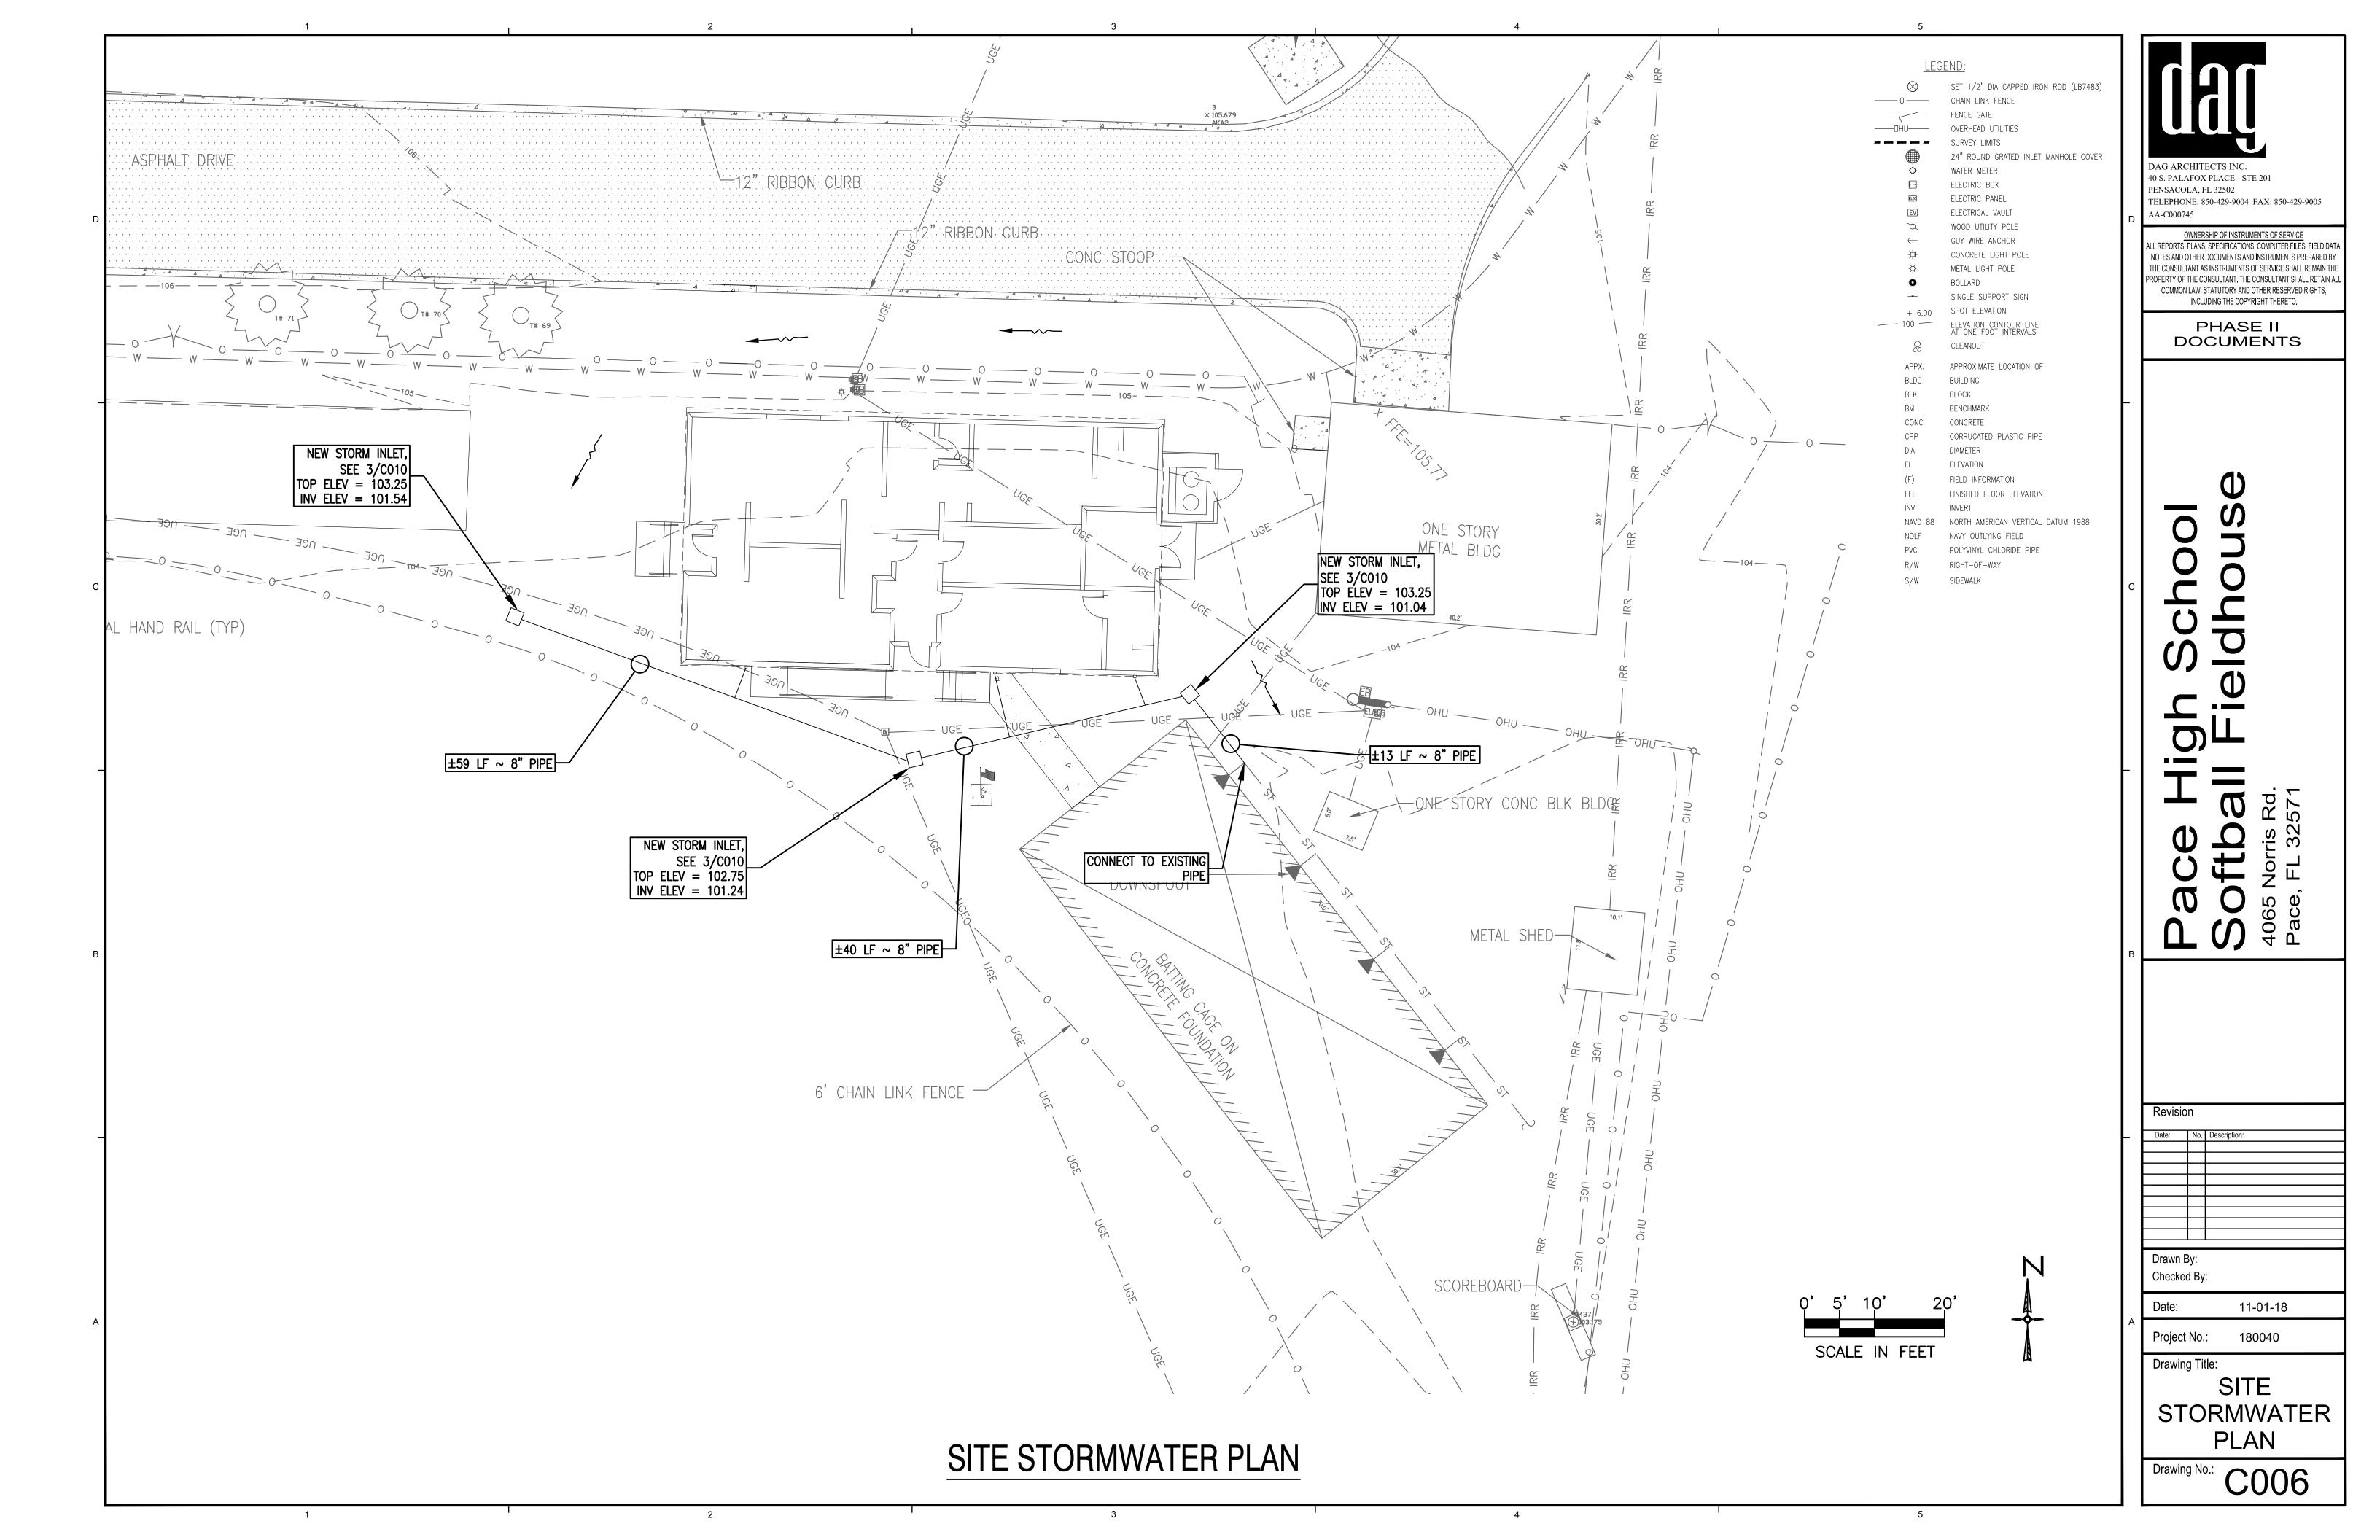OPENINGS TO 6'-4"




PRECAST OPTION

NOTES:
1.) UNLESS DETAILED OR NOTED OTHERWISE
2.) 8" MINIMUM BEARING EACH END
3.) SEE ARCH FOR BOTTOM OF LINTEL ELEVATION

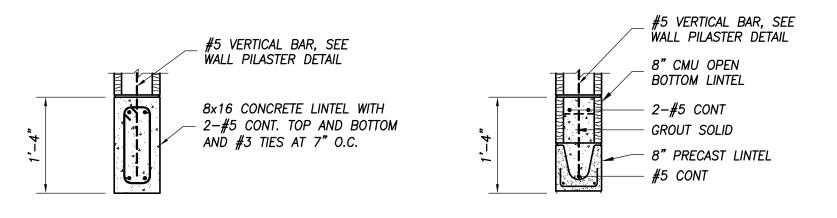
OPENINGS TO 8'-0"

TYPICAL CMU WALL OPENING LINTEL DETAILS Scale: 3/4' = 1'-0"

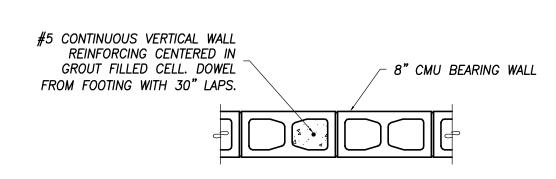



PROVIDE PILASTERS AS INDICATED ON PLANS THUS: ⊠
LOCATE AT ALL CORNERS, OPENINGS AND OTHERWISE NOT TO
EXCEED 2'-8" EXTERIOR AND 4'-0" O.C. INTERIOR BLOCK BEARING
WALLS. REFER TO TYPICAL PARTITION WALL DETAIL SHEET S201 FOR
INTERIOR BLOCK PARTITION WALLS.

TYPICAL CMU WALL PILASTER DETAIL Scale: 3/4' = 1'-0"

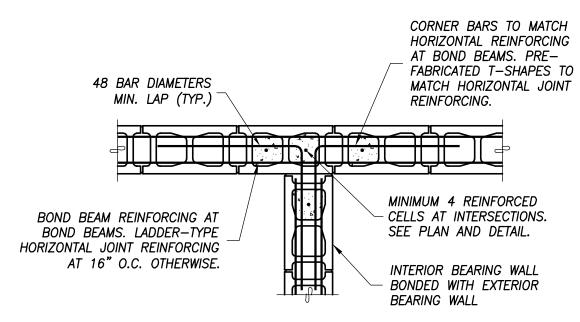

TYPICAL CMU WALL INTERSECTION DETAIL Scale: 3/4' = 1'-0"

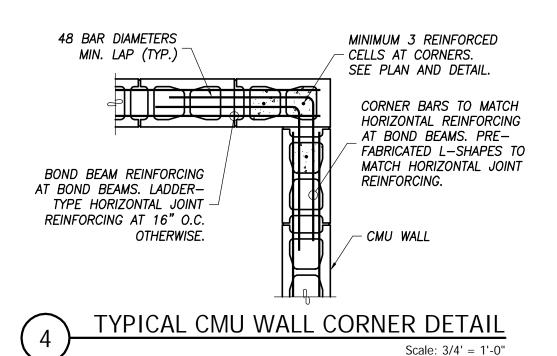

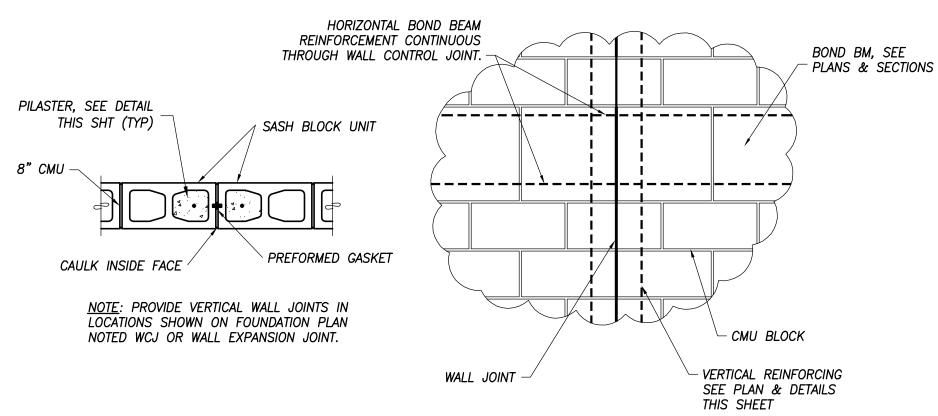


TYPICAL CMU WALL CONTROL JOINT DETAILS

Scale: 3/4' = 1'-0"

The same of the sa

TYPICAL SLAB CONTROL JOINT DETAIL

Scale: 3/4' = 1'-0"

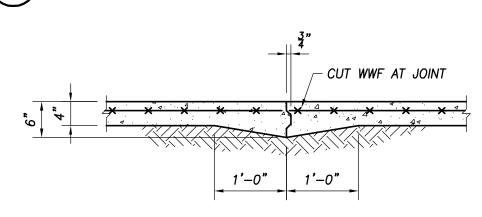

7 TYPICAL SLAB CONSTRUCTION JOINT DETAIL

Scale: 3/4' = 1'-0'

ULTIMATE WIND LOAD PRESSURE TABLES MAXIMUM WALL COMPONENT AND CLADDING

ULTIMATE WIND PRESSURES

FFECTIVE WIND AREA (SQ. FT.)	ALL ZONES (+) PRESSURE (PSF)	ZONE 4 (–) PRESSURE (PSF)	ZONE 5 (–) PRESSURE (PSF)
10	52	56	69
20	49	53	64
50	46	51	58
100	44	48	53
200	42	46	49
500	39	43	43
	•		

MAXIMUM ROOF COMPONENT AND CLADDING				
	ULTIMATE	WIND PR	ESSURES	
EFFECTIVE WIND AREA (SQ. FT.)	ALL ZONES (+) PRESSURE (PSF)	ZONE 1 (–) PRESSURE (PSF)		ZONE 3 (–) PRESSURE (PSF)
10	23	56	94	141
20	22	55	84	117
50	20	53	71	85
100	18	52	61	61

ULTIMATE WIND PRESSURE TABLES NOTES:

LINEAR INTERPOLATION FOR INTERMEDIATE VALUES OF EFFECTIVE AREAS IS ACCEPTABLE. OTHERWISE, USE THE LOAD ASSOCIATED WITH THE LOWER EFFECTIVE AREA.


ULTIMATE WIND LOAD PRESSURES ARE FOR USE IN LOAD COMBINATIONS LISTED IN FBC 6TH EDITION (2017) AND ASCE 7—10. THESE COMBINATIONS ARE LISTED IN FBC SECTION 1605 AND INCLUDE A WIND LOAD FACTOR OF 0.6 USING ALLOWABLE STRESS DESIGN.

WIND PRESSURE ZONES 2, 3 & 5 ARE EDGE AND CORNER ZONES. WALL ZONE 5 IS WITHIN 4'-0" OF OF CORNERS. REFER TO UPLIFT MAP ON SHEETS S103 AND S104 FOR ROOF ZONES.

SLAB EDGE 2-#5 BAR X 4'-0" CENTERED IN SLAB

8 TYPICAL SALB RE-ENTRANT CORNER BAR DETAIL

Scale: 3/4' = 1'-0"

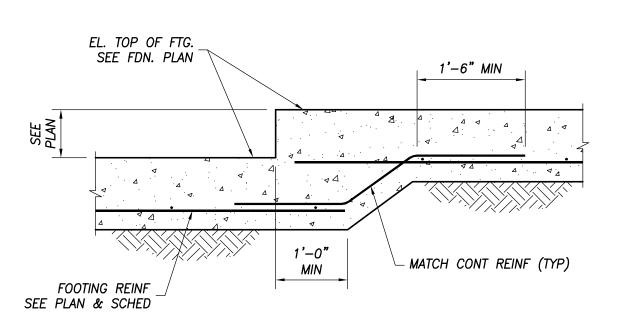

9 TYPICAL STEP FOOTING DETAIL
Scale: 3/4' = 1'-0"

GENERAL NOTES:

1. MATERIALS TO CONFORM TO THE FOLLOWING:

E 5 (—) URE (PSF)	CONCRETE CONCRETE BLOCK (CMU) BLOCK MORTAR
69	BLOCK WALL GROUT
64	REINF STEEL WELDED WIRE FABRIC
58	STR STEEL (W) STR STEEL (HSS)
53	MISC STR STEEL ANCHOR BOLTS
49	LIGHT STEEL FRMG
43	
	STEEL ROOF DECK

ASTM A185 (FLAT SHEETS)

ASTM 992 GR 50

ASTM A500 GR B

ASTM A36

OR BOLTS

ASTM A307 OR F1554, GR 36

ASTM A1003, STRUCTURAL GRADE

\$\frac{3}{8}"-18 \ GA \ STUD (362S162-43)

AROOF DECK

ASTM A108 GA GALVANIZED

TYP

EXPANSION ANCHORS

SCREW ANCHORS

SIM

TYPE B (WIDE RIB) RED HEAD TRUBOLT OR EQUIV. SIMPSON TITEN HD OR EQUIV.

3,000 PSI AT 28 DAYS

ASTM C476 (3,000 PSI)

ASTM A615 GRADE 60

ASTM C270 TYPE S

ASTM C90 (f'm = 1,500 PSI)

2. MINIMUM SUPERIMPOSED DESIGN LOAD REQUIREMENTS PER FLORIDA BUILDING CODE 6TH EDITION 2017 AND WIND LOAD REQUIREMENTS PER ASCE 7—10:

ROOF LIVE LOAD = 20 PSF

ULTIMATE DESIGN WIND SPEED = 160 MPH

NOMINAL DESIGN WIND SPEED = 124 MPH


BUILDING RISK CATEGORY III

EXPOSURE CATEGORY C

ENCLOSED BUILDING (±0.18 INTERNAL PRESSURE COEFFICIENT)


SEE DRAWINGS FOR COMPONENT & CLADDING PRESSURES

- 3. DESIGN ALLOWABLE SOIL BEARING PRESSURE IS 2,000 PSF. PREPARE SITE IN ACCORDANCE WITH THE GEOTECHNICAL ENGINEERING REPORT PREPARED BY UNIVERSAL ENGINEERING SCIENCES REPORT NO. 1613151 DATED OCTOBER 10, 2018.
- 4. ALL ELEVATIONS REFERENCED ON THE STRUCTURAL DRAWINGS ARE ABOVE OR BELOW A FINISHED FLOOR ELEVATION OF +0'-0". SEE ARCHITECTURAL AND CIVIL SITE GRADING PLAN FOR THE ACTUAL ELEVATION.
- 5. PLACE REINFORCING IN CONCRETE WITH A MINIMUM OF 3" CLEAR COVER WHEN CAST AGAINST AND PERMANENTLY EXPOSED TO EARTH. PROVIDE CORNER BARS FOR ALL CONTINUOUS HORIZONTAL REINFORCING.
- 6. ADJUST FOOTING ELEVATIONS AS REQUIRED TO CLEAR DRAIN LINES.
- 7. FIELD VERIFY ALL EXISTING BUILDING DIMENSIONS SHOWN ON PLANS. ALSO SEE ARCHITECTURAL FOR DIMENSIONS AND COORDINATE.

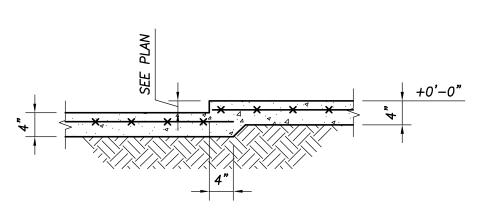

TYPICAL RECESSED SLAB DETAIL

Scale: 3/4' = 1'-0"

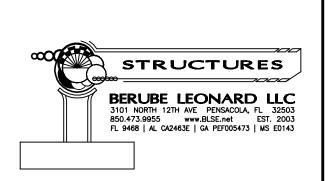

Stephen W. Leonard, PE (FL Lic. No. 60370)



DAG ARCHITECTS INC.

40 S. PALAFOX PLACE - STE 201 PENSACOLA, FL 32502 TELEPHONE: 850-429-9004 FAX: 850-429-9005 AA-C000745

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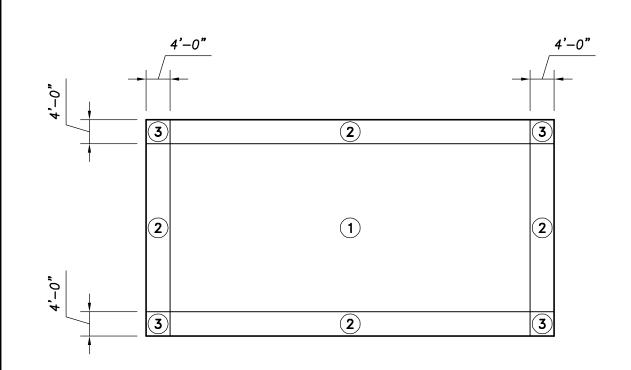
Date: 11-01-18

Project No.: 18045

Drawing Title:

GENERAL NOTES AND TYPICAL DETAILS

Drawing No.: SOO






ROOF JOIS	ST NE	T UPLI	FT LO	ADS (F	PSF)
EFFECTIVE WIND AREA	(1)	(2)	(3)	OVERH	HANGS
OF ROOF COMPONENT		2	3)	(2)	3
10 SQ FT	-28	-51	<i>−79</i>	N/A	N/A
20 SQ FT	-27	-45	-64	N/A	N/A
50 SQ FT	-26	-37	-45	N/A	N/A
100 SQ FT	-25	-31	-31	N/A	N/A

NET UPLIFT TABLE NOTES:

LINEAR INTERPOLATION FOR INTERMEDIATE VALUES OF EFFECTIVE AREAS IS ACCEPTABLE. OTHERWISE, USE THE LOAD ASSOCIATED WITH THE LOWER EFFECTIVE AREA.


NET UPLIFT LOADS ARE CALCULATED FROM ALLOWABLE STRESS DESIGN LOAD COMBINATION .6D+.6W WHERE .6D = 6 PSF.

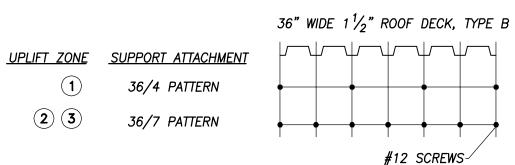


ROOF DECK NOTES:

1. FASTEN DECK TO SUPPORTS WITH #12-14 SELF DRILLING SELF TAPPING SCREWS AT FASTENER PATTERN SHOWN ABOVE. FASTEN AT 6" O.C. ALL DIAPHRAGM BOUNDARIES; EAVES, RAKES & RIDGES.

2. PROVIDE #10-16 SCREW SIDE-LAP FASTENERS AT 12" O.C. MAX PER SPAN BETWEEN SUPPORTS.

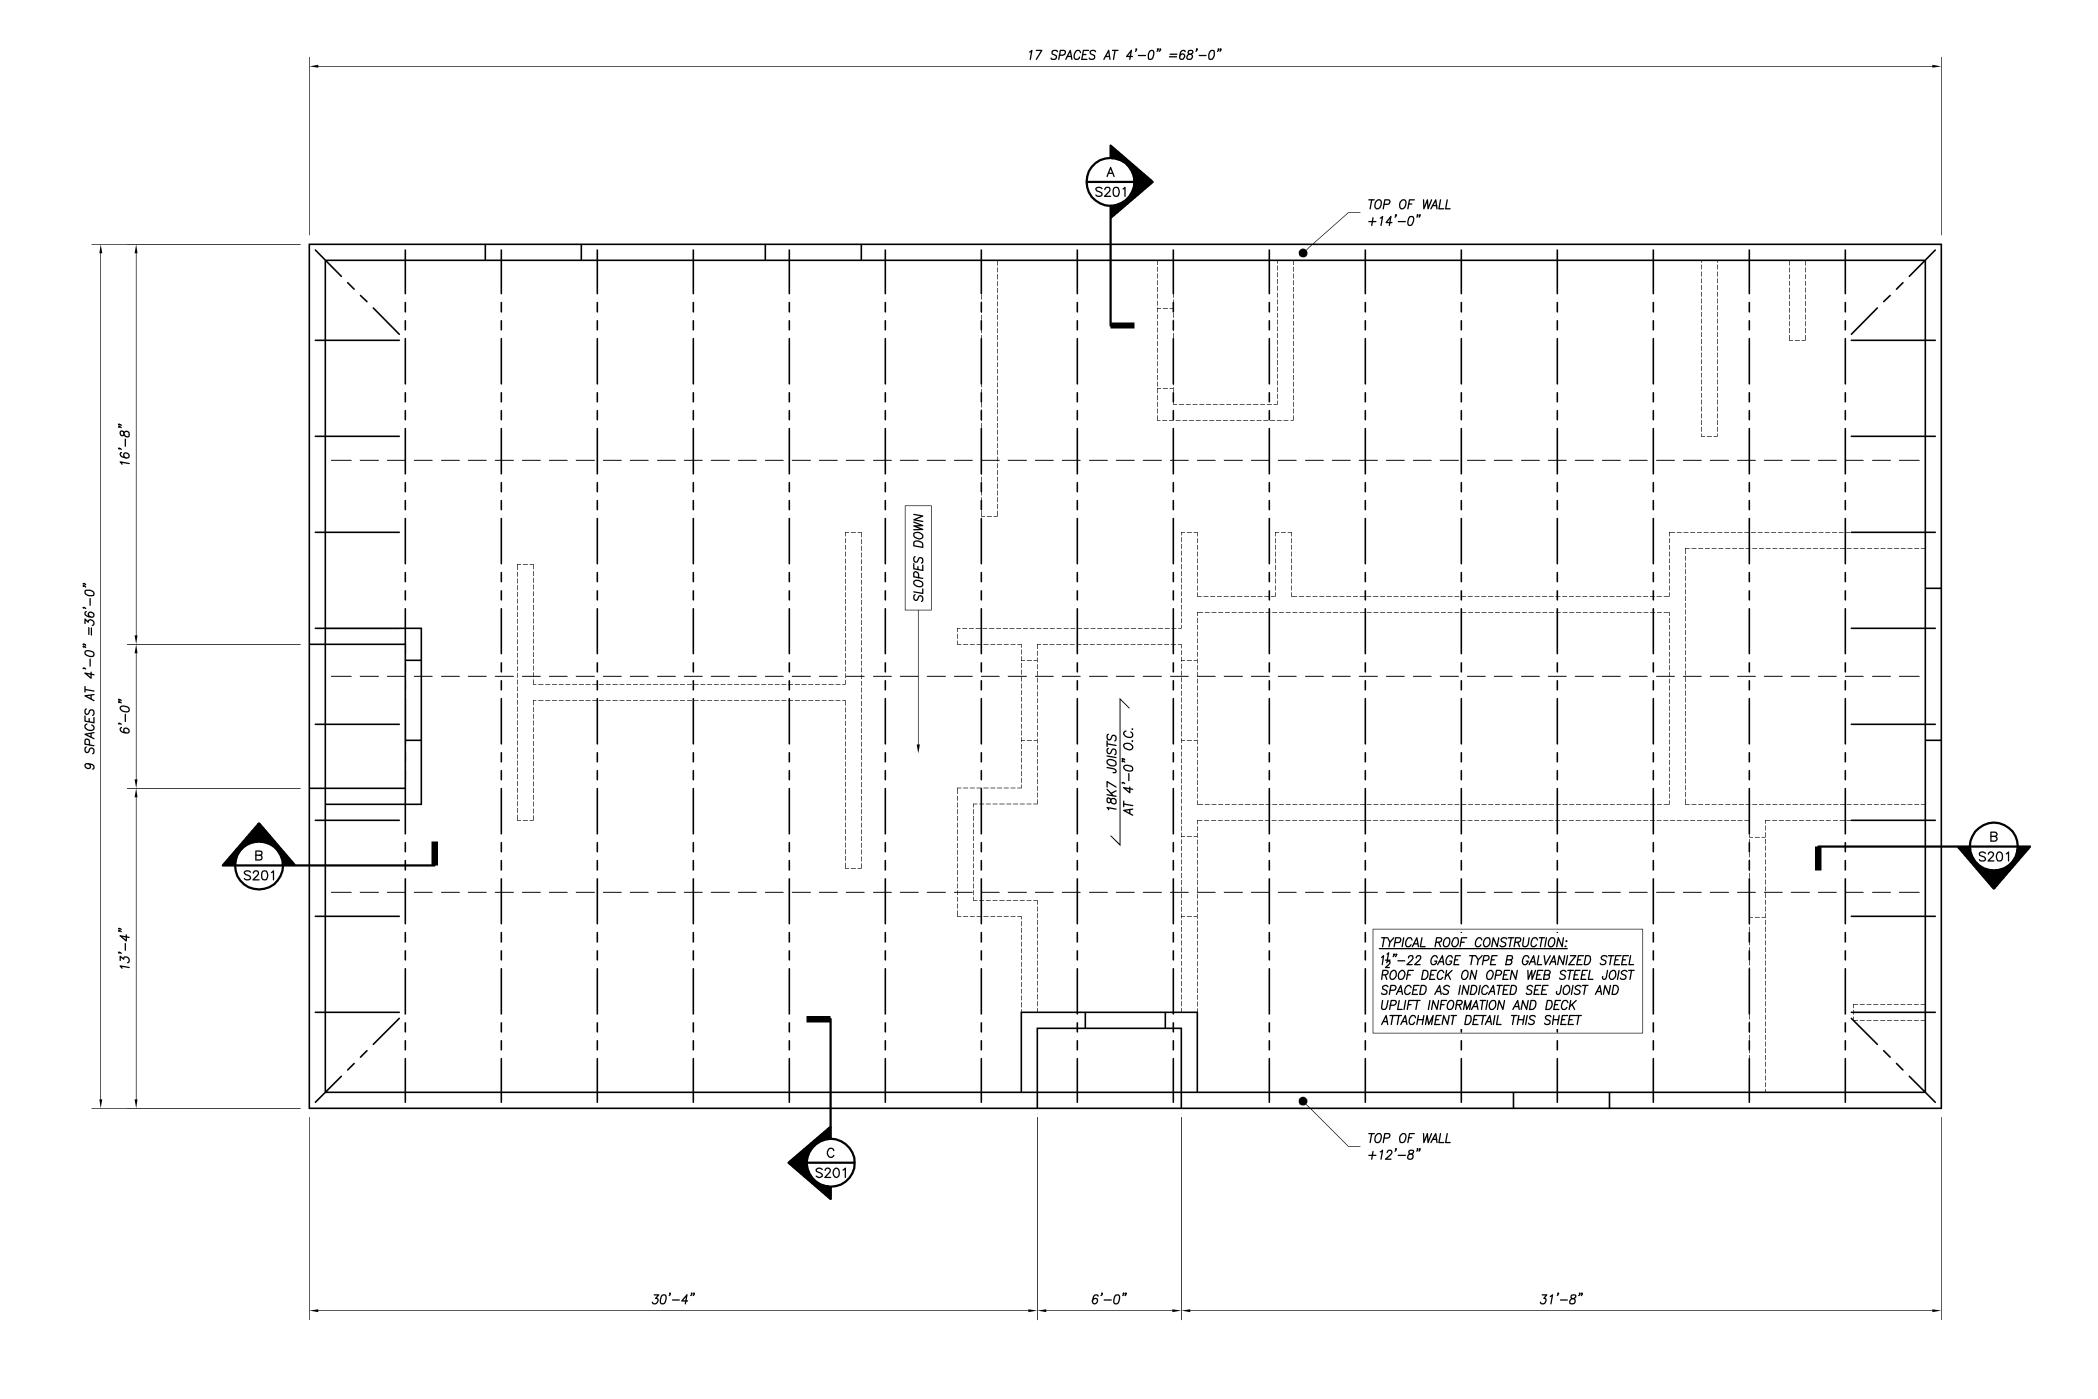

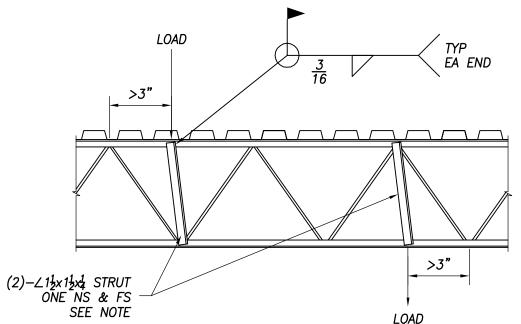


NOTE: A STRUT IS REQUIRED IF ANY OF THE FOLLOWING CONDITIONS OCCUR WITHIN A SINGLE PANEL;


- 1. A SINGLE POINT LOAD GREATER THAN 100 LBS
- 2. THE SUM OF MULTIPLE POINT LOADS IS GREATER THAN 100 LBS


3. ANY POINT LOAD, REGARDLESS OF THE MAGNITUDE, THAT HAS NOT BEEN EVENLY DISTRIBUTED TO BOTH ANGLES OF THE SUPPORTING CHORD (E.G. A BEAM CLAMP ATTACHED TO ONE SIDE OF THE CHORD)

TYPICAL JOIST REINF. DETAIL

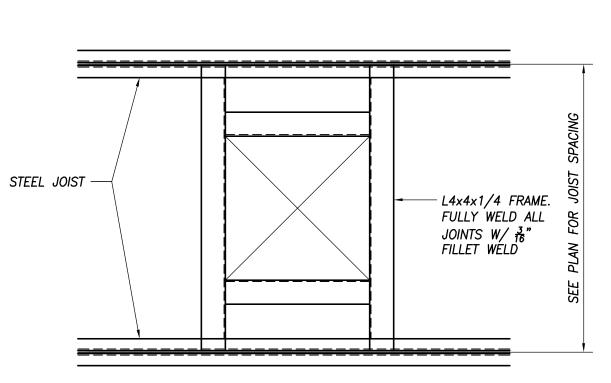

<u>NOTE</u>: REQUIRED FOR OPENINGS 12" AND LARGER. COORDINATE LOCATIONS WITH MECHANICAL CONTRACTOR.

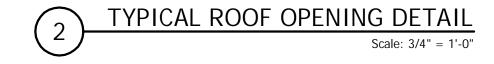


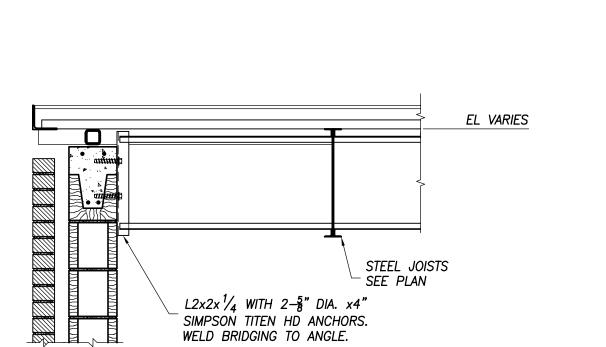

TYPICAL JOIST BRIDGING ANCHORAGE DETAIL



ROOF FRAMING PLAN

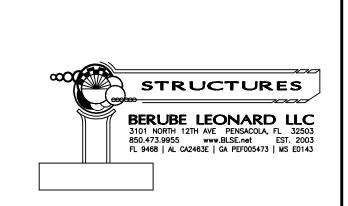

Stephen W. Leonard, PE (FL Lic. No. 60370)

DAG ARCHITECTS INC. 40 S. PALAFOX PLACE - STE 201

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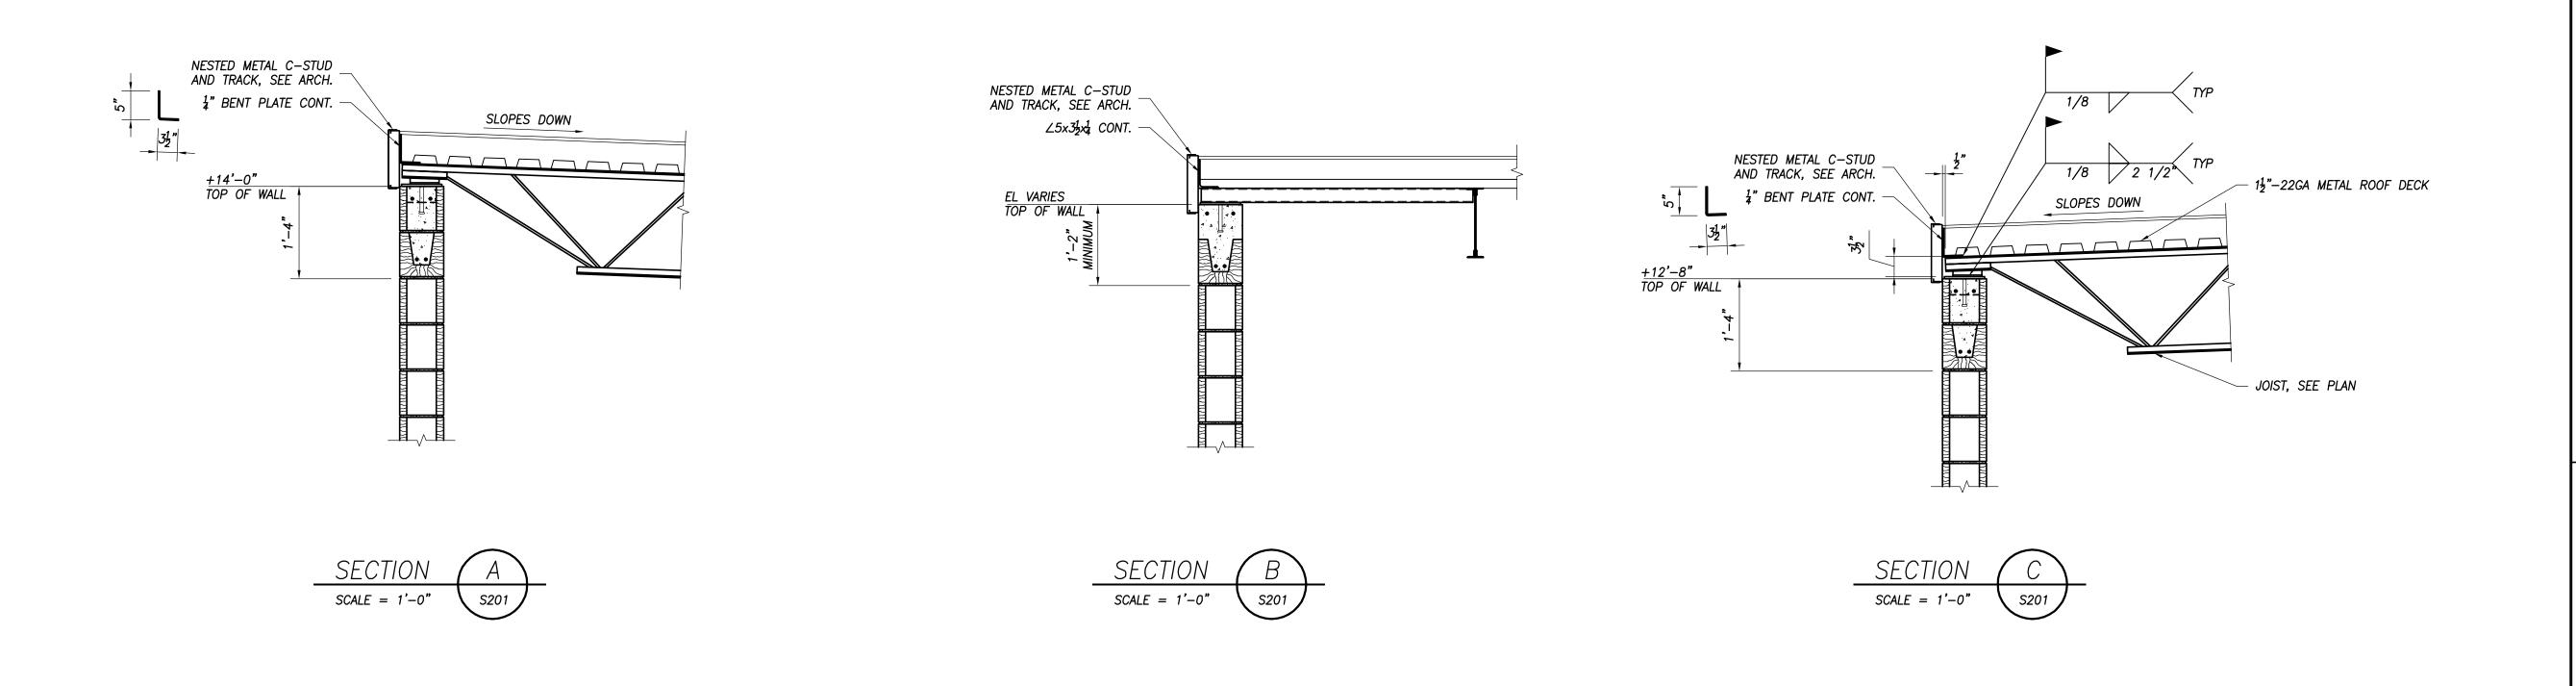
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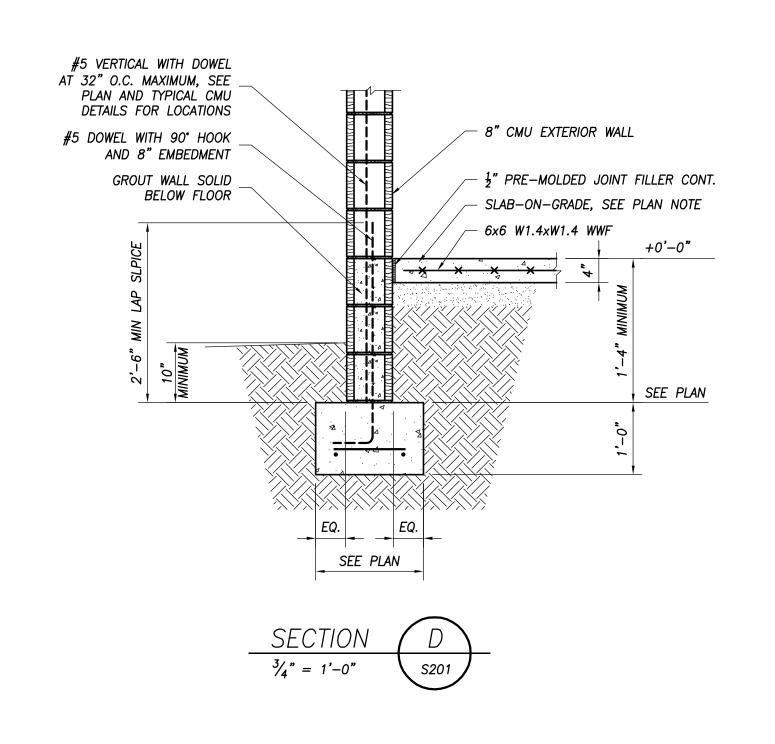
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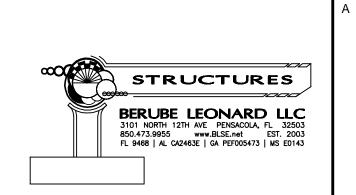
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Drawing Title:

ROOF FRAMING PLAN TYPICAL JOIST AND DECK DETAILS







Stephen W. Leonard, PE (FL Lic. No. 60370)

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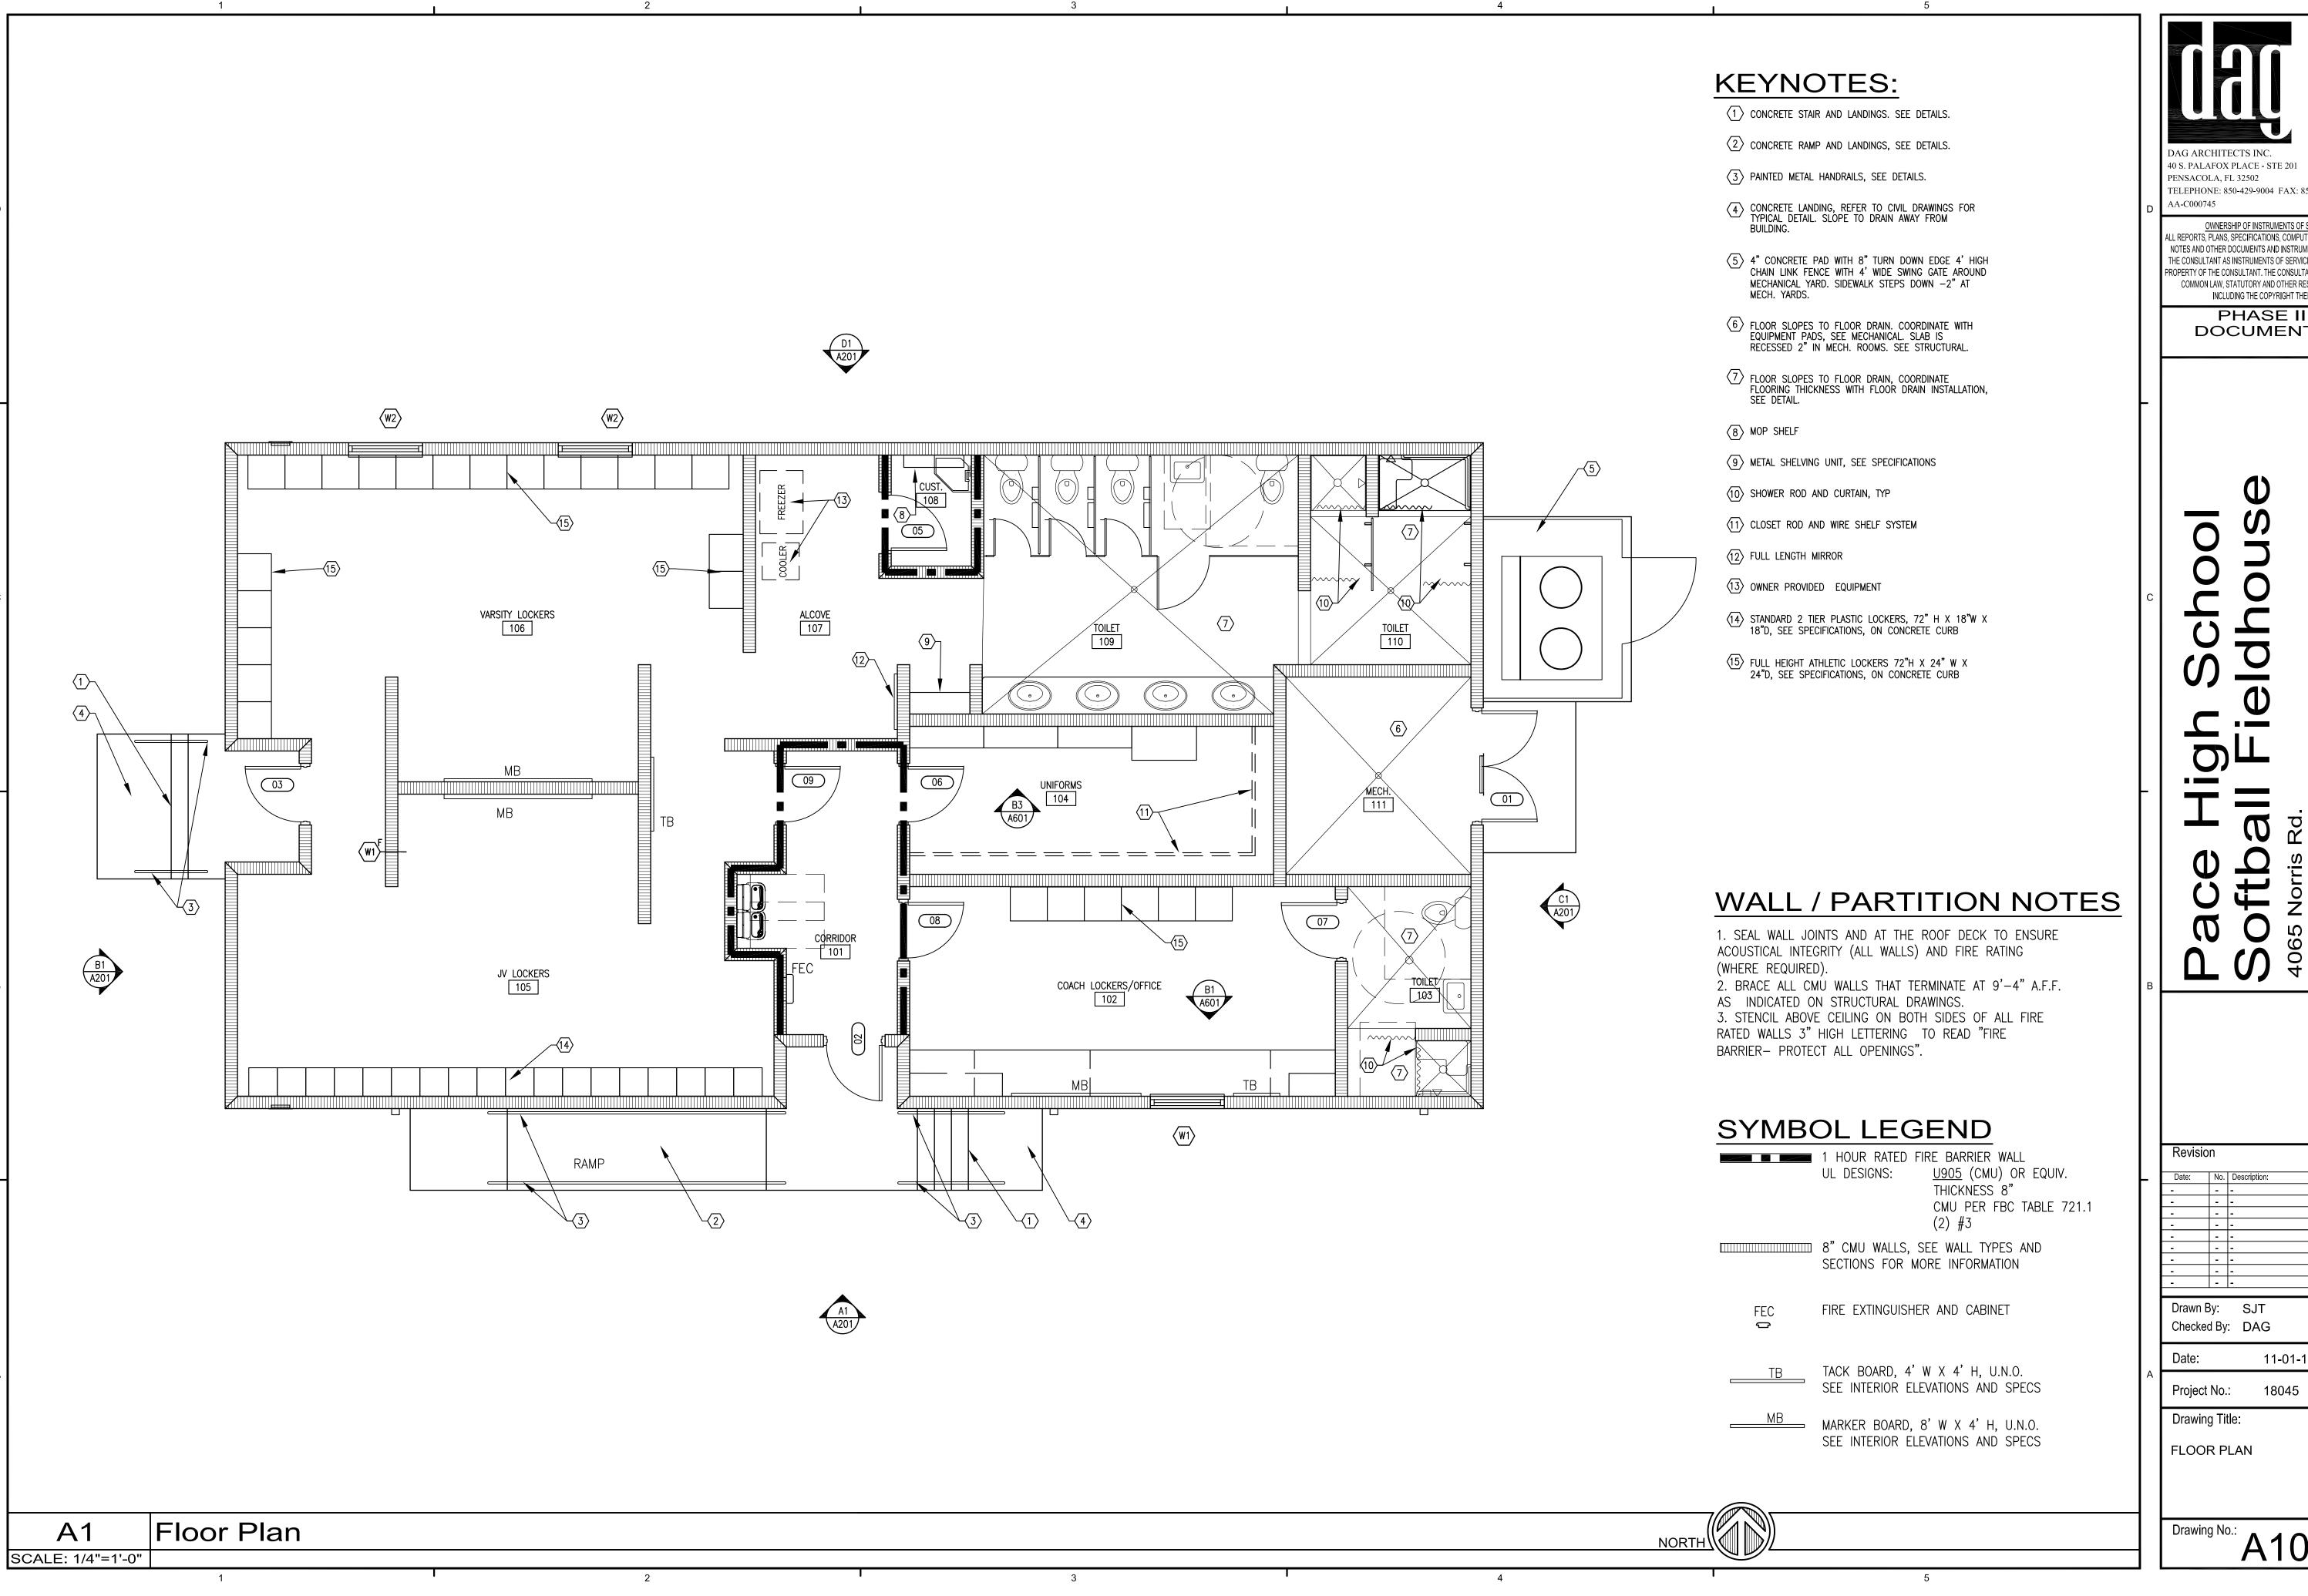
Date: 11-01-18

Project No.: 18045

Drawing Title:

SECTIONS AND DETAILS

Drawing No.: S20



Drawing No.: A101

11-01-18

DAG ARCHITECTS INC. 40 S. PALAFOX PLACE - STE 201 PENSACOLA, FL 32502 TELEPHONE: 850-429-9004 FAX: 850-429-9005 AA-C000745

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> PHASE II DOCUMENTS

KEYNOTES:

- PROVIDE SUPPLEMENTAL FRAMING AND TRIM AT SOFFIT MOUNTED FIXTURES. REFER TO MEP FOR ADDITIONAL INFORMATION AND SPECIFIC LOCATIONS.
- PROVIDE 24" X 24" CEILING ACCESS PANEL, SEE SPECIFICATIONS.

SYMBOL LEGEND STRUCTURE VARSITY LOCKERS TOILET 106 1.10 GYPSUM BOARD CEILING OR SOFFIT METAL SOFFIT PANELS UNIFORMS MECH. 104 SOFFIT MOUNTED FIXTURE-REFER TO ELECTRICAL DWGS HVAC RETURN AIR GRILLE-REFER TO MECHANICAL DWGS 2x4 FLUORESCENT LIGHT FIXTURES SOFFIT MOUNTED VENT, REFER TO MECH. DRAWINGS V LOCKERS 105 COACH LOCKERS/OFFICE WALL MOUNTED FIXTURE— REFER TO ELECTRICAL DWGS HVAC SUPPLY DIFFUSER OR GRILL- REFER TO MECHANICAL DWGS 24" X 24" CEILING ACCESS PANEL, COORDINATE LOCATION IN FIELD TO PROVIDE MAINTENANCE ACCESS WHERE NEEDED

2

EXPOSED STRUCTURE (NO CEILING)
WALLS TO EXTEND TO UNDERSIDE OF

SUSPENDED ACOUSTICAL CEILING TILE

GENERAL NOTES (REFLECTED CEILING):

1. SEE FINISH SCHEDULE FOR ADDITIONAL INFORMATION. REFER TO ELECTRICAL DOCUMENTS FOR SPECIFIC FIXTURE TYPES.
 REFER TO MECHANICAL DRAWINGS FOR ADDITIONAL INFORMATION.

Project No.: 18045

Date:

Drawn By: SJT

Checked By: DAG

Revision

DAG ARCHITECTS INC.

PENSACOLA, FL 32502

AA-C000745

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> PHASE II DOCUMENTS

Drawing Title:

REFLECTED CEILING PLAN

11-01-18

A1 SCALE: 1/4"=1'-0" Floor Plan

NORTH

