CLASSROOM ADDITION JAY ELEMENTARY SCHOOL

13833 S ALABAMA ST.

JAY, FL 32565

FOR THE SCHOOL BOARD OF SANTA ROSA COUNTY

PHASE II CONSTRUCTION DOCUMENTS

ARCHITECT OWNER CONTACTS STRUCTURAL PLUMBING MECHANICAL DAG Architects, Inc. 40 South Palafox Place, Suite 201 Pensacola, Florida 32502 Santa Rosa County School Board Santa Rosa County, FL Berube-Leonard, LLC 3101 N. 12th Ave Schmidt Consulting Group, Inc. 40 S. Palafox Place, Suite 300 Schmidt Consulting Group, Inc. 40 S. Palafox Place, Suite 300 Pensacola, FL 32502 Phone: 850-438-0050 Phone: 850-983-5123 Suite 102 Pensacola FI 32502 Suite 102 Pensacola, FL 32503 Phone: 850-473-9955 Ext 103 Fax: 850-473-1770 Fax: 850-983-5115 Phone: 850-429-9004 Phone: 850-438-0050 Fax: 850-432-8631 Joseph B. Harrell Administrative Superintendent for Administrative Services PIC: Dave Luttrell, AIA PIC: Stephen W Leonard, PE Email: joe@schmidtconsulting Email joe@schmidtconsulting Email: ogipson@dagarchitects.com Email: steve@blse.net group.com group.com Harrelj@mail.santarosa.k12.fl.us ELECTRICAL TELECOMMUNICATIONS: CIVIL & SURVEYING: Schmidt Consulting Group, Inc. 40 S. Palafox Place, Suite 300 Schmidt Consulting Group, Inc. 40 S. Palafox Place, Suite 300 Jehle-Halstead, Inc. 5414 Highway 90 Pensacola FL 32502 Pensacola FL 32502 Milton, FL 32571 Phone: 850-438-0050 Phone: 850-994-9503 Fax: 850-432-8631 Fax: 850-432-8631 Fax: 850-994-9504 Todd Nicholson, PE Todd Nicholson, PE Patrick Jehle, Jr. E.I. Email: toddn@schmidtconsulting Email: toddn@schmidtconsulting Email pjehle@jehle-halstead.com group.com group.com

Project Teams and Discipline

Allocation

SCALE NTS

PROJECT INDEX:

GENERAL: Set Cover Sheet - Project Stats Sheet Index Design Team A000

MECHANICAL SHEETS:

M101 M201 M301 M302 M303 M304 M305 M306 M307 M401 M402 M403

LORIDA PRODUCT APPROVAL NUMBERS

Mechanical Schedules

Mechanical Controls

Electrical Legend, Notes, Electrical Site Plan Electrical Lighting Plan Electrical Power Plan Mechanical Power Plan Electrical Systems Plan Electrical Details

Electrical Single Line Diagram Electrical Single Line Diagram Electrical Panel Schedules

STATE

ELECTRICAL SHEETS:

Mechanical Plan

Notes & Information Existing Site Conditions Site Demolition Plan Site Improvements Plan

Site Phasing plan Site Dimensioning Plan Site Grading Plan Site Storm Water & Utility Plan Miscellaneous Site Construction Details Site Storm Water & Utility Details Site Storm Water & Utility Details Site Erosion Control Details

STRUCTURAL:

General Notes & Typical Details Foundation Plan Roof Framing Plan Sections & Details Sections & Details

ARCHITECTURAL SHEETS:

ng Heights & Accessories Sched. Symbols

Life Safety Plan (600 Wing) / Code Data

Construction Access Site Plan

A100 A101 A101.1 A101.2 A101.3 A101.4 A201 A301 A310 A311 A331 A501 Construction Access Sit Floor Plan Dimension Floor Plan Reflected Ceiling Plan Roof Plan Signage and Finish Plar Exterior Elevations Building Sections Wall Sections Wall Sections

Wall Sections
Details
Door and Frame Schedule Door, Frame and
Window Types, Room Finish Schedule
Door and Frame Details and Window Details
Interior Elevations

A502 A601 A611 A612

PLUMBING SHEETS:

AG SHEETS:
Plambing Notes, Legend, and Abbreviations
Plambing schedules
Santary and Vent Plan
Domestic Water Plan
Plambing Plan
Plambing Plan
Plambing Details
Riser Diagram and Details


B4

SCALE NTS

A4

SCALE NTS

Project Sheet Index

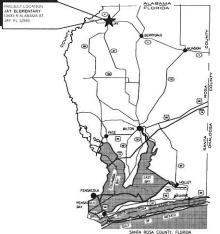

Vicinity Map

CONSTRUCTION

ary ‹dditior Š OM 0 em S <u>ŏ</u> S Alabama 3 2565 S S

Drawn By Checked By OFG

Project No. 17052 Drawing Title

Set Cover Sheet -Project Stats, Code Review, Sheet Index & Design Team

A-000

GENERAL NOTES

- THE CONTRACTOR IS RESPONSIBLE FOR PROVIDING THE ENGINEER WITH A SIGNED AND SEALED SURVEY AS-BUILT DRAWING AT THE END OF CONSTRUCTION, SURVEY MUST INCLUDE DEFAUED TOPOGRAPHY AND IDEMPRICATION OF ALL ON-GRADE FRATURES; TOP, BOTTOW, AND INVEST LEAVED AND AND SANITARY SEVER STRUCTURES, INCLUDING CLEAVOUTS; STORM AND SANITARY FER ROUTING AND PIPE SZEZS; AND APPROXIMATE LOCATIONS OF UNDERGROUND UTILITIES BASED ON REDUINE MARKUPS TO BE PROVIDED BY THE CONTRACTOR (LABELED/NOTED AS "APPROXIMATE", "PER CONTRACTOR REDLINES", OR SIMILAR AT THE DISCRETION OF THE SURVEYOR OF RECORD).
 ALL DISTURBED AREAS (NOT PAVED) TO BE STABILIZED WITH SOD.

- ALL LANDSCAPE AND SOD/GRASS AREAS MUST BE FULLY IRRIGATED.

 TREES NOT BEING REMOVED MUST BE PROTECTED PER DETAILS PRESENTED IN THE PLANS.
- ALL TREE PROTECTION BARRICADES MUST BE PLACED PRIOR TO COMMENCEMENT OF ANY SITE WORK, INCLUDING LAND CLEARING, AND MUST BE ALL SITE DRAINAGE INCLUDING ROOF DRAINS, DOWN SPOUTS, OR GUTTERS ARE TO BE ROUTED TO CARRY ALL STORM WATER TO THE
- PROPOSED STORM WATER MANAGEMENT SYSTEM
- PROFUSE STORM WITHER MAINDEMONING TOTALS.

 THE LOCATIONS OF KNOWN UNDERGROUND UTILITIES ARE SHOWN IN AN APPROXIMATE WAY ONLY AND HAVE NOT BEEN INDEPENDENTLY VERIFIED. THE CONTRACTOR MUST DETERMINE THE EXACT LOCATION OF ALL EXISTING UTILITIES BEFORE COMMENCING WORK AND AGREES TO BE FULLY RESPONSIBLE FOR ANY AND ALL DAMAGES WHICH MIGHT BE OCCASIONED BY THE CONTRACTOR'S FAILURE TO EXACTLY LOCATE AND PRESERVE ANY AND ALL UNDERGROUND UTILITIES.
- PRESENTE ANY ANI ALL UNDERGROUND UTILITIES.

 4. CONTRACTOR SESPONSIBLE FOR INSTALLATION, PROR TO CONSTRUCTION, AND MANTENANCE/REPAIRS, DURING CONSTRUCTION, OF SEDMENT AND EROSON CONTROL MESSURES AS REQUIRED TO BETAIN ALL SEDMENT AND EROSON ON THE SITE OF DEVELOPMENT. THE PROVISIONS AS SHOWN ON THESE PLANS REPRESENT THE MAINIMAIN BROSON CONTROL MESSURES TO BE TRACK, AND CONTROL MESSURES AS RECESSARY AT NO ADDITIONAL COST TO THE OWNER DURING CONSTRUCTION, IMPROPER SEDMENT CONTROL MESSURES MAY RESULT IN CODE ENFORCEMENT VOLATION.
- ALL ASPECTS OF THE STORM WATER/DRAINAGE COMPONENTS AND/OR TRANSPORTATION COMPONENTS MUST BE COMPLETED PRIOR TO ISSUANCE OF A FINAL CERTIFICATE OF OCCUPANCY.
- 6. CONTRACTOR MUST RESHAPE PER PLAN SPECIFICATIONS, CLEAN OUT ACCUMULATED SILT, AND STABILIZE RETENTION/DETENTION POND(S) AND ADJACENT ROADSIDE DITCH SYSTEMS AT END OF CONSTRUCTION WHEN ALL DISTURBED AREAS HAVE BEEN STABILIZED.

 7. ANY DAMAGE TO EXISTING ROADS DURING CONSTRUCTION WILL BE REPAIRED BY THE CONTRACTOR PRIOR TO FINAL "AS-BUILL" SICH-OFF FROM
- THE CONTRE OR HIS AGENT MUST ARRANGE/SCHEDULE WITH THE COUNTY A FINAL INSPECTION OF THE DEVELOPMENT UPON COMPLETION AND ANY INTERMEDIATE INSPECTIONS. AS-BUILT CERTIFICATION IS REQUIRED PRIOR TO REQUEST FOR FINAL APPROVAL.

- ANT INTERMEDIATE INSPECTIONS. AS-BOLL CONTINUATION IS REQUIRED FROM IN REQUEST FOR FINAL APPROVAL.

 9. THIS PROJECT MUST BE BUILT IN ONE PHASE.

 10. NOTIFY SUNSHINE UILLIES 48 HOURS IN ADVANCE PRIOR TO DIGGING WITHIN P/M; 811.

 11. NO DEVARIANCE OR REVISIONS FROM THESE PLANS BY THE CONTRACTOR WILL BE ALLOWED WITHOUT PRIOR WRITTEN APPROVAL FROM THE DESIGN ENGINEER AND NOTIFICATION OF COUNTY ENGINEERING. ANY DEVARIONS MAY RESULT IN DELAYS IN OBTAINING A CERTIFICATE OF
- 12. THE CONTRACTOR MUST COMPLY WITH ALL FEDERAL AND STATE REGULATIONS CONCERNING NOTIFICATION TO THE REGULATORY AUTHORITIES OF ANY AND ALL BUILDING RENOVATIONS AND/OR DEMOLITION.
- CONTRACTOR MUST PROTECT EXISTING AND RELOCATED SIGNS IN THE RIGHT-OF-WAY. CONTRACTOR MUST REPLACE DAMAGED SIGNS AND/OR
 POST IF DAMAGE OCCURS DURING CONSTRUCTION ACTIVITIES.
- 14. IT IS THE CONTRACTOR'S RESPONSIBILITY TO PROTECT ALL BENCHMARKS DURING CONSTRUCTION, INCLUDING ALL PUBLIC AND PRIVATE LAND CORNER MONUMENTATION. IF A PUBLIC OR PRIMATE CORNER IS IN DANGER OF BEING DISTURBED AND HAS NOT BEEN PROPERLY REFERENCED, THE WILL BE RESPONSIBLE FOR REPUEMENT OF THE MONUMENT AT A LOCATION DETRINANT BY STUTINGED OR ECFROPESSIONAL SURVEYOR WILL BE RESPONSIBLE FOR REPUEMENT OF THE MONUMENT AT A LOCATION DETRINANT BY A STUTINGED LICENSED PROFESSIONAL SURVEYOR AND MAPPER USING GUIDELINES AS ESTABLISHED BY NATIONAL GEODETIC SURVEY FOR BLUE BOOKING AND APPROVAL.

SITE DATA SUMMARY

PROP. REF. NO.	19-5N-29-0000-06900-0000
PARCEL AREA	39.01 ACRE (1,699,276 SF)
STREET ADDRESS	4949 ALABAWA ST. JAY, FLORIDA 32565
CURRENT USE	PUBLIC SCHOOL
ZONING	MIX: CITY & P2 (ACTIVE PARK)
SETBACKS	FRONT: TBD BACK: TBD SIDE: TBD
STORMWATER	
PROJECT AREA	100775 SF (100%)
EXISTING	
PERVIOUS	70030 SF (69%)
IMPERVIOUS	30745 SF (31%)
BUILDING, MISC.	00000 SF (00%)

PERVIOUS	70204 SF (70%)
IMPERVIOUS	18014 SF (18%)
BUILDING, MISC.	12557 SF (12%)
FLOOD ZONE	THE PARCEL SHOWN IS L

ONE	THE PARCEL SHOWN IS LOCATED
OIL	WITHIN THE FOLLOWING FLOOD
	ZONE(S) AS DETAILED BY FEMA
	FIRM (FLOOD INSURANCE RATE
	MAP) INFORMATION DESCRIBED BELOW:

FLOOD ZONE (S)		MAP NUMBER*	PANEL NUMBER(S)	WAP SUFFIX*	REVISION DATE
X	120339	12113C	0035	G	DECEMBER 19, 2006

TREE INFORMATION

TREE #	SPECIES	CANOPY	DIAMETER
2101	OAK	60'	28*
2102	OAK	60'	30°
2103	OAK	15'	15*
2104	PINE	25'	24*
2105	CREPE MYRTLE CLUSTER	5'	4*
2106	CREPE MYRTLE CLUSTER	5'	4*
2107	CREPE MYRTLE CLUSTER	5'	4"
2108	CREPE MYRTLE CLUSTER	5'	4"
2109	CREPE MYRTLE CLUSTER	5'	4*
2287	PECAN	40'	30°
2288	0AK	60'	60"
3234	PINE	60'	28*
3235	PINE	40'	28*
3236	OAK	65'	36"
3237	HICKORY	50'	28*
3238	OAK	50'	30°
3239	OAK	30'	32*
3240	OAK	30'	32*
3241	OAK	80'	36*
4184	MAGNOLIA	40'	15*

	DEVELOPER / PROJECT OWNER JOEY HARRELL, ASST SUPF FOR ADMIN SVCS SANTA ROSA COUNTY SCHOOL BOARD 6544 FIREHOUSE ROAD MILTON, FL 32570
	Sheet List Table
Sheet Number	Sheet Title
C000	NOTES AND INFORMATION
C001	EXISTING SITE CONDITIONS
C002	SITE DEMOLITION PLAN
C003	SITE IMPROVEMENTS PLAN
C004	PHASING PLAN
C005	SITE DIMENSIONING PLAN
C006	SITE GRADING PLAN
C007	SITE STORM WATER & UTILITY PLAN
C008	MISCELLANEOUS SITE CONSTRUCTION DETAILS
C009	SITE STORM WATER & UTILITY DETAILS
C010	SITE STORM WATER & UTILITY DETAILS
C011	SITE EROSION CONTROL DETAILS

NOTES AND INFORMATION

UTILITY COMPANIES

CARLE TELEVISION -BRIGHT HOUSE NETWORKS 240 S HWY 97 CANTONNENT, FLORIDA

ELECTRIC ESCAMBIA RIVER ELECTRIC CO-OP, INC. 3425 FL-4 JAY FLORIDA (850) 675-7439

GENESIS PIPELINE, USA (251) 296-1439

NATURAL GAS — GULF SOUTH PIPELINE CO LP 480 VAN PELT LANE PENSACOLA, FLORIDA

SANITARY SEWER / POTABLE WATER -TOWN OF JAY (850) 675-4556

MS

0

Δ

1

F

☐ WPB

+ 600

100 -

MEMORIAL STONE UTILITY SPOT LOCATION

6" ROUND AWNING SUPPORT POLE

3" SQUARE AWNING SUPPORT POLE 4" SQUARE AWNING SUPPORT POLE

4" ROUND AWNING SUPPORT POLE

SINGLE SUPPORT SIGN

DETECTABLE WARNING PAD

ELEVATION CONTOUR LINE AT ONE FOOT INTERVALS

RADIO MAST

PICNIC TABLE

WIRE PULL BOX

SPOT ELEVATION

BOLLARD

TELEPHONE -AT&T DISTRIBUTION (561) 997-0240

PROJECT AREA

VICINITY MAP PROPERTY OWNER TIM WYROSDICK, SUPERINTENDENT SANTA ROSA COUNTY SCHOOL BOARD 5086 CANAL ST

MILTON, FL 32570

ø	FOUND 4"X4" CONCRETE MONUMENT (FDOT)		CONCRETE AREAS
*	SET BENCHMARK		
0	CHAIN LINK FENCE	XXXX	COVERED CONCRETE ARE
⊗	CHAIN LINK FENCE WITH VISION SLATS	XXXX	X2
HU	OVERHEAD UTILITIES		
w	BURIED WATER LINE		
BE	BURIED ELECTRIC LINE	A/C	AIR CONDITIONER
вт ——	BURIED TELEPHONE LINE	APPX.	APPROXIMATE LOCATION OF
OC	BURIED FIBER OPTIC CABLE	BFP	BACKFLOW PREVENTOR
	GUARD RAIL	BOC	BACK OF CURB
	LANDSCAPING AREA	BM	BENCHMARK
	SURVEY LIMITS	CLF	CHAIN LINK FENCE
	SOLID WHITE PAINT LINE	CMP	CORRUGATED METAL PIPE
	SOLID YELLOW PAINT LINE	CONC	CONCRETE
	SOLID BLUE PAINT LINE	CPP	CORRUGATED PLASTIC PIPE
	DOUBLE YELLOW PAINT LINE	DIP	
\rightarrow	FLOW LINE		DUCTILE IRON PIPE
0	STORMWATER MANHOLE	EOP	EDGE OF PAVEMENT
	DROP INLET	EL	ELEVATION
0	ADS YARD INLET	ERCP	ELLIPTICAL REINFORCED
0	WATER METER		CONCRETE PIPE
M	WATER VALVE	FFE	FINISHED FLOOR ELEVATION
H	FIRE HYDRANT	FDOT	FLORIDA DEPARTMENT OF
A.	FIRE DEPARTMENT CONNECTION		TRANSPORTATION
A	DOWNSPOUT	GSP	GALVANIZED STEEL PIPE
(S)	SEWER MANHOLE	INV	INVERT
0	CLEANOUT	LSA	LANDSCAPING AREA
Ň	SEWER VALVE	MES	MITERED END SECTION
EB	ELECTRIC BOX	NAVD 88	NORTH AMERICAN VERTICAL
EM	ELECTRIC METER	ORGERAL	DATUM 1988
O	ELECTRIC VAULT	PVC	POLYVINYL CHLORIDE PIPE
€D	ELECTRICAL MARKER	RCP	REINFORCED CONCRETE PIP
	ELECTRIC PANEL	R/W	RICHT-OF-WAY
CM	GAS METER	S/W	SIDEWALK
(CR)	GAS REGULATOR	(TYP)	TYPICAL FEATURE
0	BURIED FIBER OPTIC CABLE MARKER	~	TREE LEGEND
CIVI	TELEPHONE VAULT	(.)	OAK
(CV)	COMMUNICATIONS VAULT	\sim	
TE	TELEPHONE PULL BOX	*	PINE
(P)	TELEPHONE PEDESTAL	1/1/1	
FDC	FIBER OPTIC CABLE WIRE PULL BOX	63	CREPE MYRTLE CLUSTER
F/A	FIRE ALARM WIRE PULL BOX	Ke Ju	
A/C	WALL MOUNT AIR CONDITIONER	\bigcirc	HICKORY
←	GUY WIRE ANCHOR		
a	WOOD UTILITY POLE	0	MAGNOLIA
Ö	LIGHT POLE	•	
	FLAG POLE	£33	PECAN

LEGEND:

OM 0 St Sro 0 S S 13833 S Jay, FL a D. PATRICK JEHLE, JR. P.E. 71528 Checked By August 1, 2018 Project No.: 170055 Drawing Title

hi jehle-halstead inc


OWARS-POFING TURN'S OF SERVICE


PHASE III


dition \triangleleft


NOTES AND INFORMATION


C000

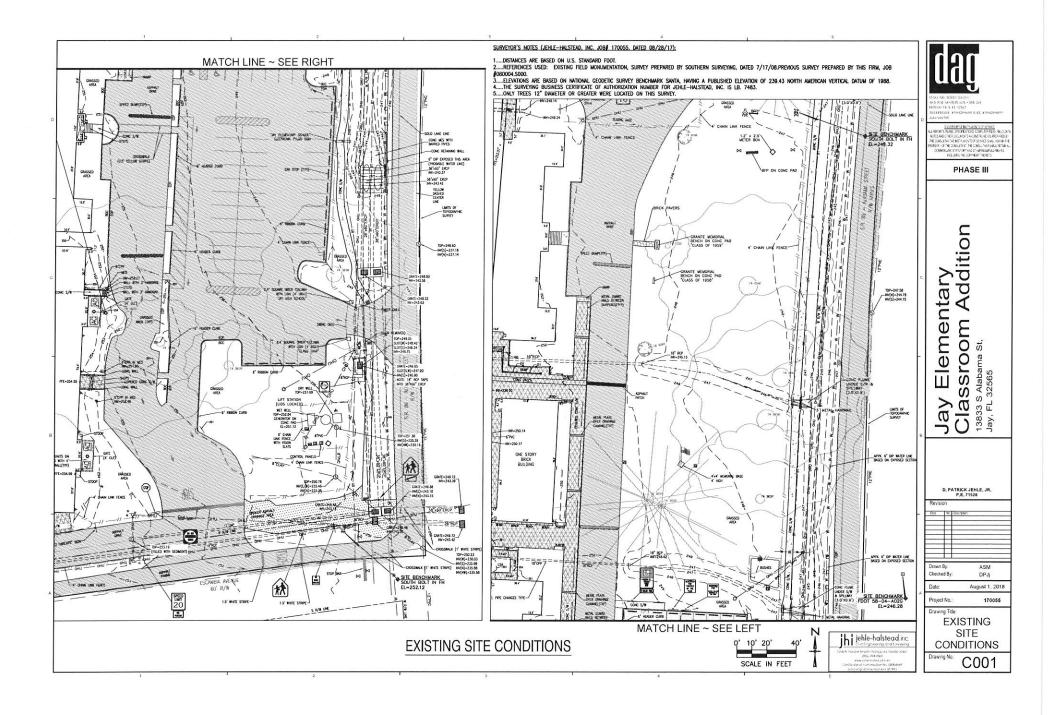


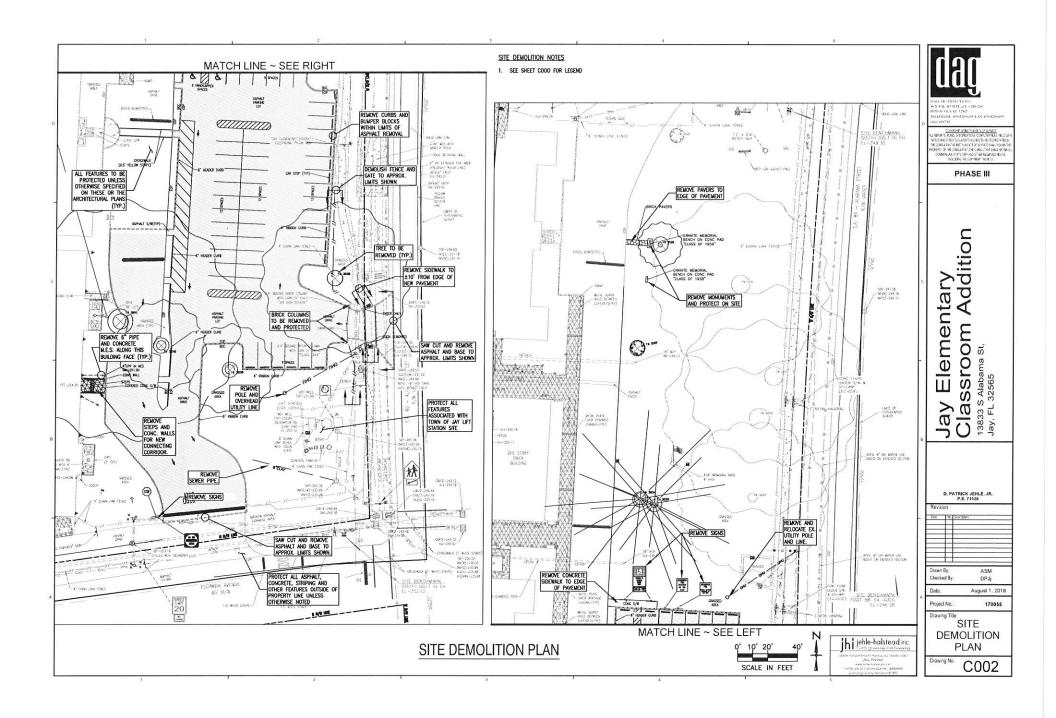


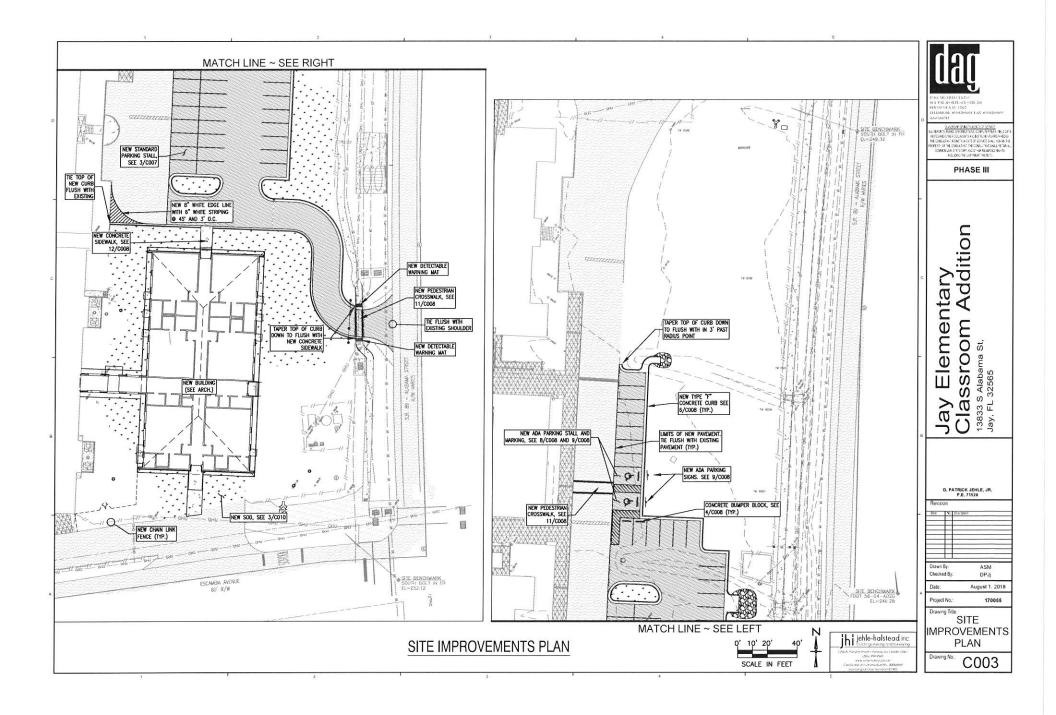


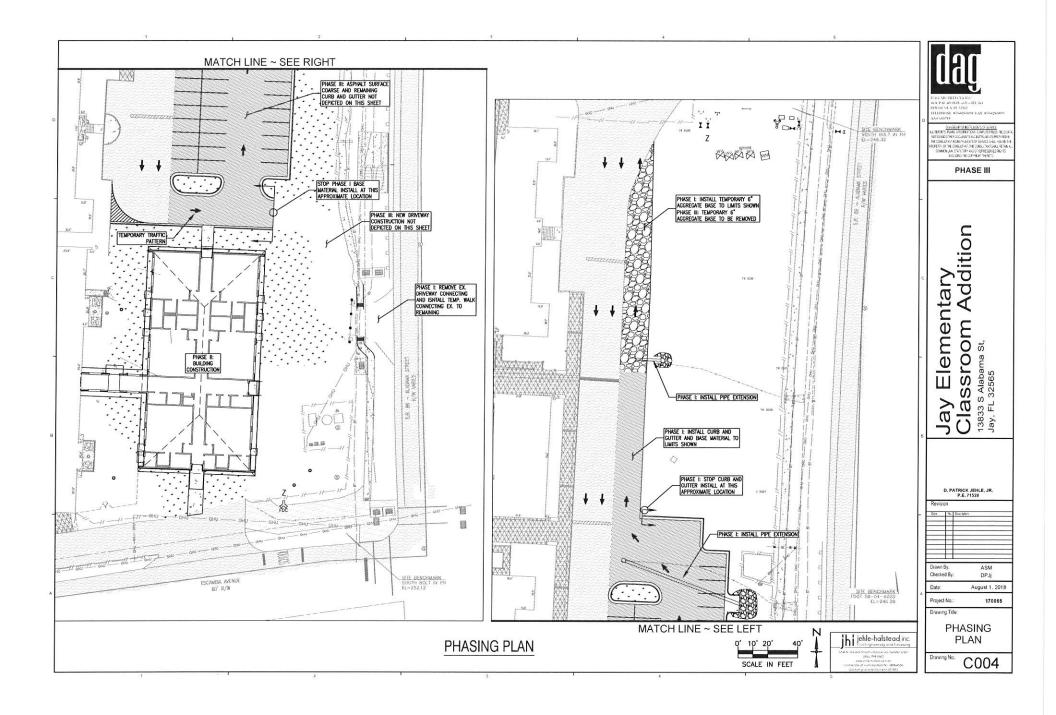


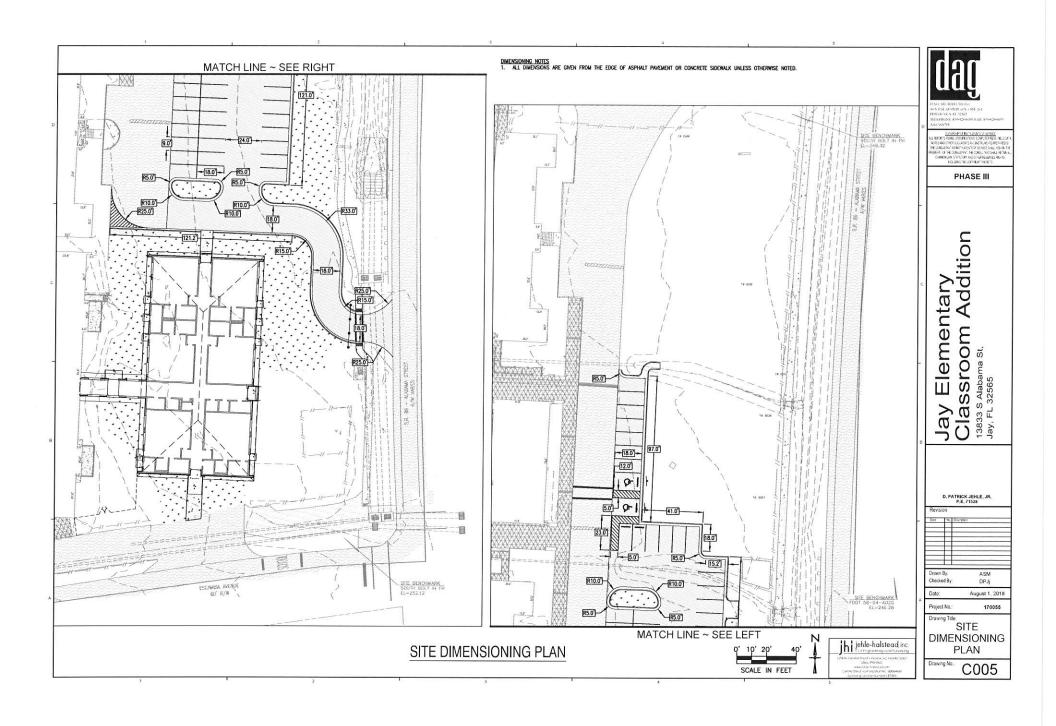


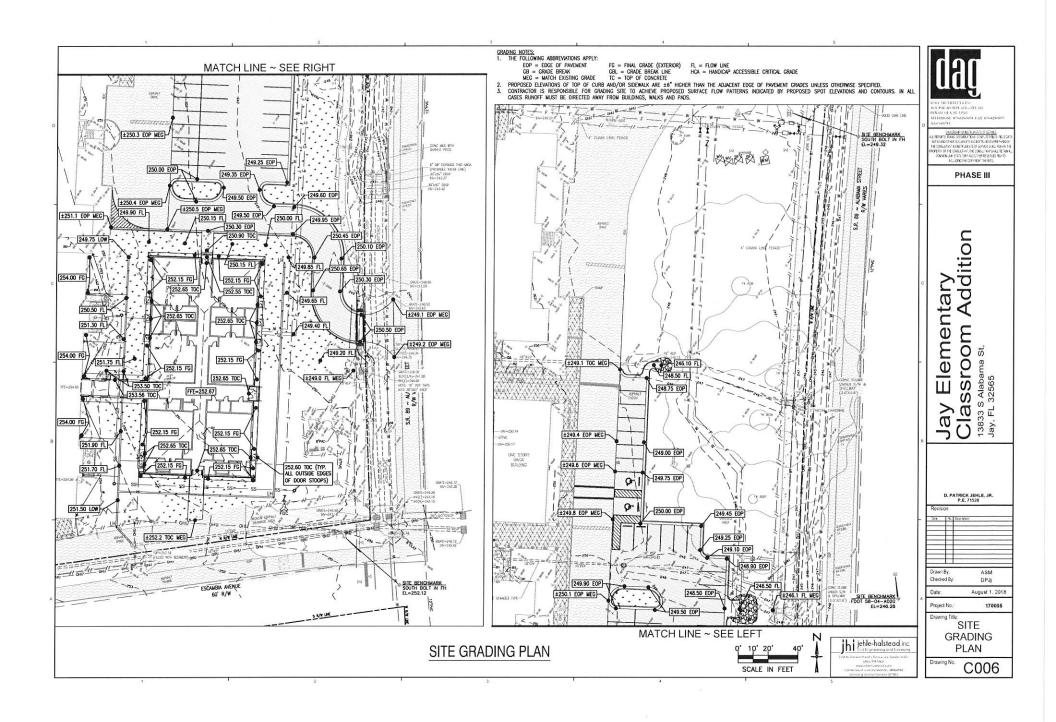


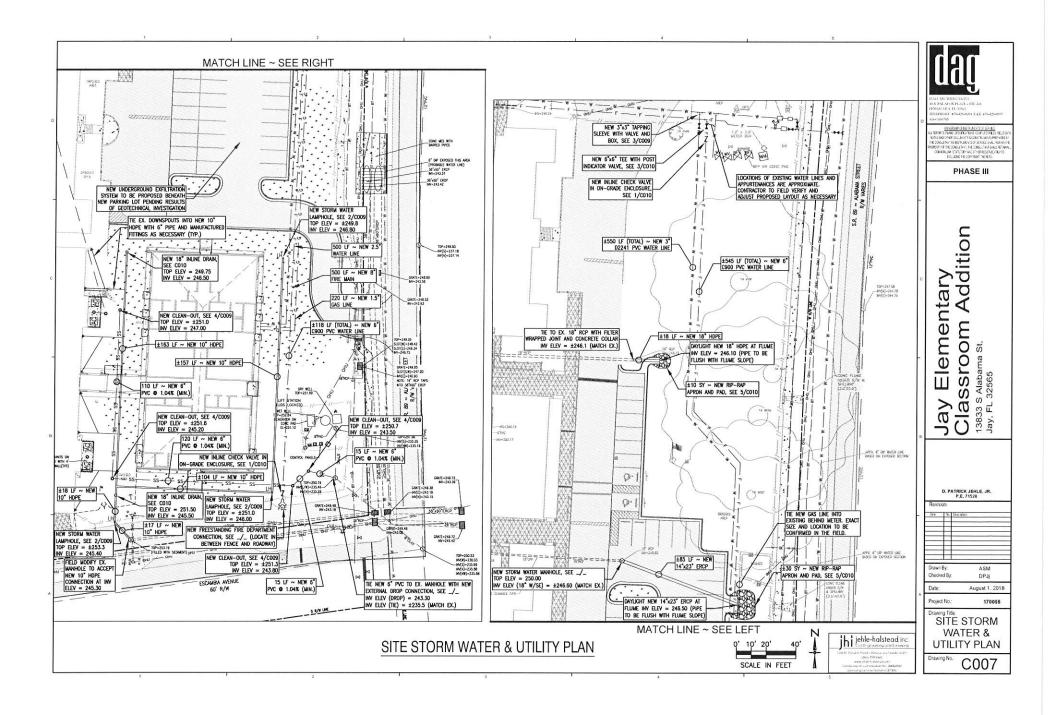


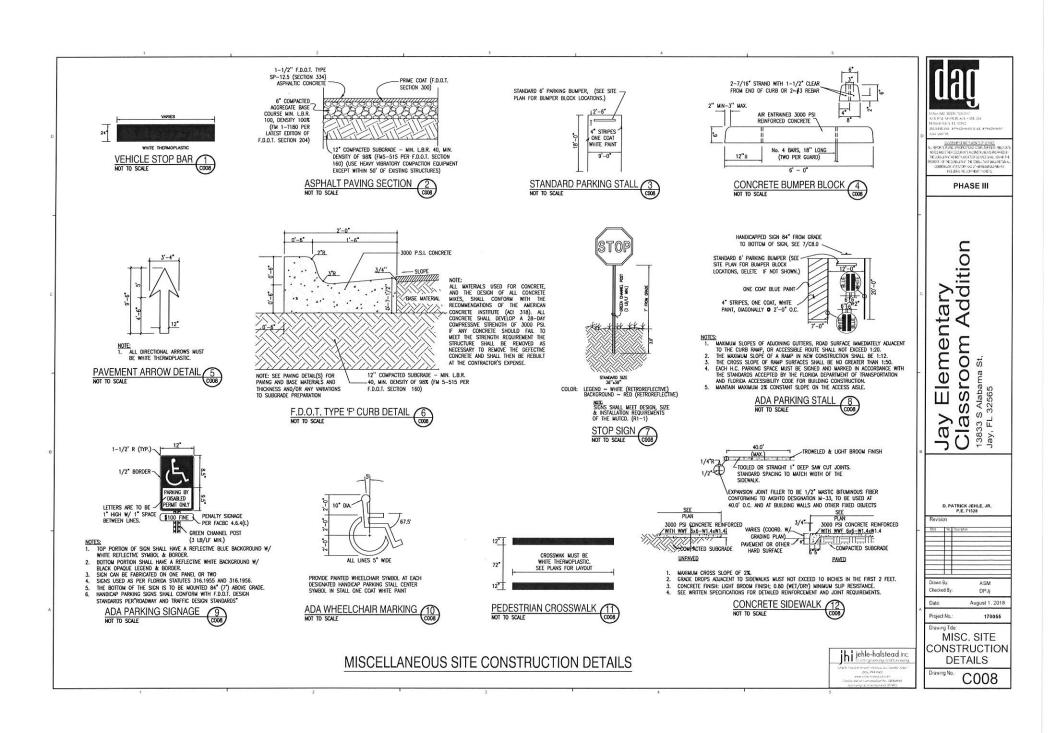


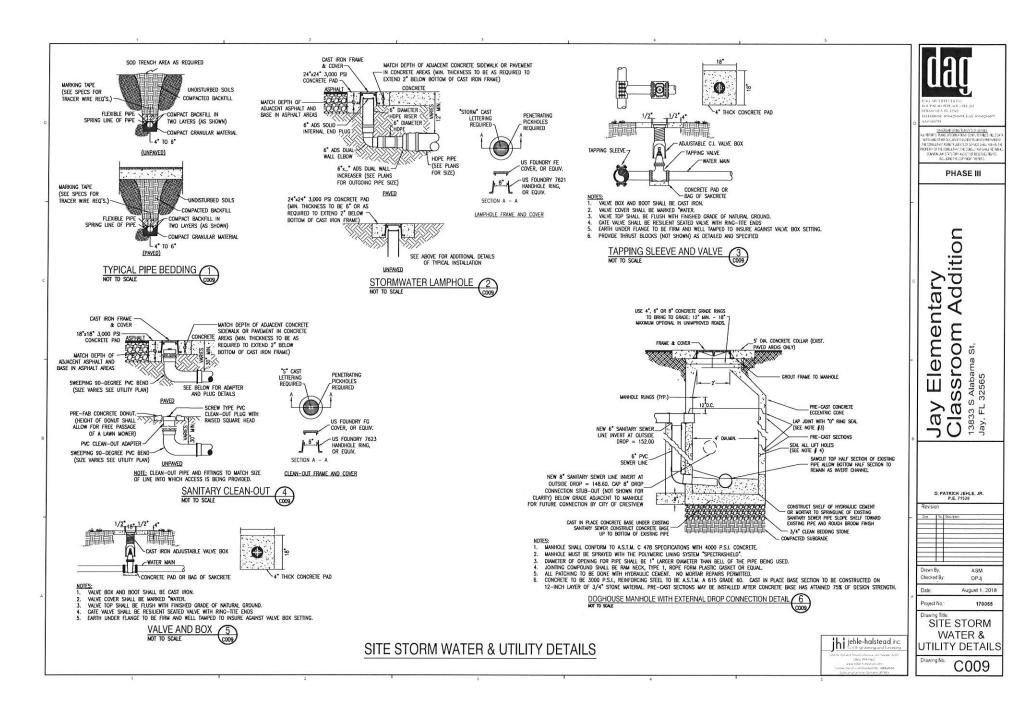

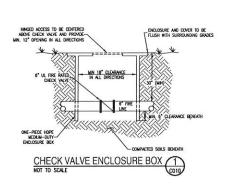

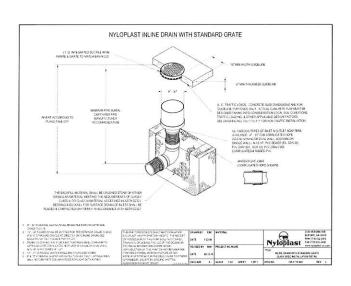

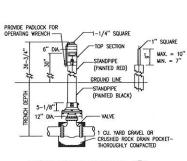

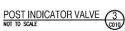

SITE STORM WATER & UTILITY DETAILS

	NOTES AND OTHER DOOR THE CONSULTANT AS INS PROFERTH OF THE CONSUL COMMENUAL STATE	SENSTRUBENS OF SCHULD OFFICITIONS COMPUTED RUBS INC. D SUCCESSACIES TO ACCESSAL VERSION RUBSENS OF SCHULD SHALL VERSION ETWIT THE COMPUTED SHALL VERSION OFFICE ACCESSACIES FOR TO THE COMPUTED SHALL VERSION OF ACCESSACIES FOR TO THE COMPUTED THE VERSION TO THE COMPUTED THE VERSION OF THE VER
	Р	HASE III
С	Jay Elementary	Classroom Addition 13833 S Alabama St, Jay, FL 32565
	D. PATE P	RICK JEHLE, JR. .E. 71578
	Drawn By: Checked By: Date:	ASM DPJj August 1, 2018

Project No.:

jhi jehle-halstead inc.

SITE STORM WATER &


UTILITY DETAILS C010

WILESS, CAST FRON VER SLEEVE	POLISHED CAPS.	CHROME PLATED,	PIN LUG, THREADED, SWIN	EL WITH CAST IRO
OLLAR WOE	18.		NOTE: PROMDE THRUST BLOCKS DETAILED AND SPECIFED	S (NOT SHOWN) AS
12		, ductile iron, dint pipe	MECHANICAL JOINT/FLANGE	
40	30. (MN)	18" (MN)	INLET BODY CAST IRON CAP COVER SLEEVE	RED GLOSSY POLYESTER
	→] ↓		LUG	NONE
BATT DISID 18, (LUNCAT)	18"	FOR ENCLOSURE GRAVEL OR CRUS	ED CHECK VALVE (SEE 5/0	xx10)

(619) NOT TO SCALE

С
j
av Flamantary
day Figure 1
Clock and and a
Classicolli Addit
13833 S Alabama St,
Jay, FL 32565

170055

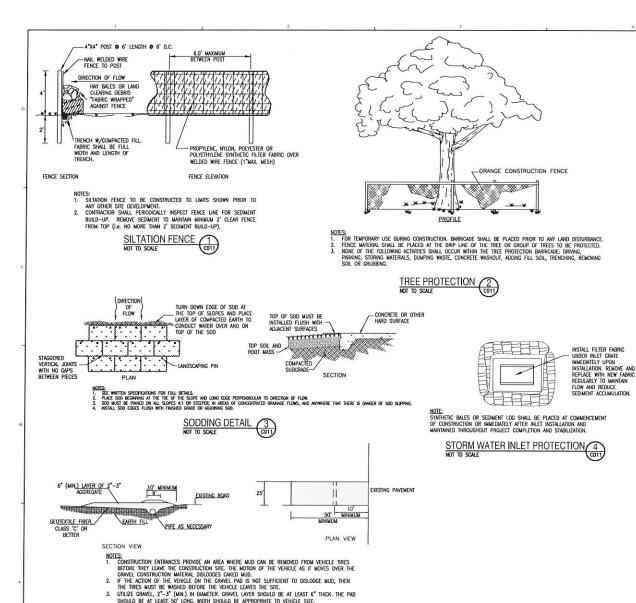

ROCK CONSTRUCTION ACCESS

GENERAL NOTES FOR EROSION AND SEDIMENT CONTROL

- CONTRACTOR WILL BE RESPONSIBLE FOR THE INSTALLATION (PRIOR TO CONSTRUCTION) AND MAINTENANCE/REPAIRS OF (DURING CONSTRUCTION) EROSION AND SEDMENT CONTROL MEASURES AS REQUIRED TO RETAIN ALL SEDIMENT AND EROSION ON THE SITE OF DEVELOPMENT, THE PROVISIONS SHOWN HEREIN REPRESENT THE MINIMUM EROSION CONTROL MEASURES TO BE TAKEN.
- 2. ALL SOLE WASHED, ROPPED, SPILLED, OR TRACKED OUTSIDE THE SITE OR ONTO PUBLIC ROPHIS-OF-WAY WILL BE REMOVED IMMEDIATELY.

 3. ALL AREAS OF DISTURBANCE MUST BE ITERATED AS APPROPRIATE TO PREVENT THE
- GENERATION OF DUST.
- GENERATION OF DUST.

 A IT HE TIME OF STIE PEPERATION FOR PERMANENT VEGETATIVE STABILIZATION, ANY SOIL THAT WILL NOT PROVIDE A SUITABLE ENVIRONMENT TO SUPPORT PERMANENT COVER MUST BE REMOVED OR TREATED IN SUCH A WAY THAT WILL PERMANENTY ADJUST THE SOIL CONDITIONS AND REMOER IT SUITABLE FOR PERMANENT COVER, IF THE REMOVAL OR TREATMENT OF THE SOIL WILL NOT PROVIDE SUITABLE CONDITIONS, NON-WEGETATIVE MEANS OF PERMANENT GROUND STABILIZATION MUST BE EMPLOYED.
- (I.E. EROSION CONTROL FABRIC, RIP-RAP, ETC.).
 THE CONTRACTOR MUST MAKE REGULAR INSPECTIONS OF ALL CONTROL MEASURES THROUGHOUT THE CONSTRUCTION PROCESS TO ENSURE THE OVERALL EFFECTIVENESS OF THE EROSION AND SEDIMENT CONTROL PLAN. AT A MINIMUM, INSPECTIONS MUST OCCUR AT LEAST ONCE A WEEK AND WITHIN TWENTY-FOUR (24) HOURS OF THE END OF A STORM EVENT THAT IS ONE-HALF (0.50) INCH OR GREATER, ALL INSPECTIONS MUST BE DOCUMENTED PER THE NPDES STORMWATER POLLUTION PREVENTION PLAN.
- In the event that an on-site inspection by any party revenior play.
 In the event that an on-site inspection by any party reveals a deficiency in the installation and/or maintenance of erosion and sediment control measures, the contractor must be responsible for the immediate remembership. OF THE PROBLEM
- 7. FAILURE TO COMPLY WITH THE REQUIRED EROSION AND SEDIMENT CONTROL GUIDELINES MAY RESULT IN FINES LEVIED BY GOVERNMENTAL AGENCIES. ANY FINES SUFFERED DUE TO NON-COMPLIANCE MUST BECOME THE RESPONSIBILITY OF THE CONTRACTOR.

SEQUENCE OF EROSION AND SEDIMENT CONTROL MEASURES IMPLEMENTATION SITE PREPARATION

- PRIOR TO ANY SOIL DISTURBANCE, SILT FENCE MUST BE INSTALLED ALONG ENTIRE DOWN-GRADE PERMETER OF PROJECT AREA, AS SHOWN IN PLANS AND DETAILS, OR BY EQUIVALENT MEASURES. SILT FENCE MUST REMAIN IN PLACE UNTIL ALL UP-GRADE AREAS OF DISTURBANCE NHWE BEEN PERMANENTLY STABILIZED.

 2. A PROPER CONSTRUCTION ENTRANCE MUST BE ESTABLISHED AT ALL POINTS OF
- INGRESS/EGRESS FROM CONSTRUCTION SITE, PER DETAIL PROVIDED IN THE PLANS, OR BY EQUIVALENT MEASURES. ALL CONSTRUCTION ENTRANCES MUST REMAIN IN PLACE UNTIL INGRESS/EGRESS FROM THE SITE AT THAT POINT HAS STOPPED.

CLEARING AND GRUBBING

- LLOWING AND GUIDBRING .

 1. ALL DISTURBED AREAS THAT WILL BE LEFT EXPOSED FOR MORE THAN FOURTEEN (14) DAYS, AND ARE NOT SUBJECT TO CONSTRUCTION TRAFFIC, MUST RECEIVE A TEMPORAY SEEDING INMEDIATELY UPON ISSURBANCE. IF THE SESSON PREVISTS ESTRUBENHENT OF A TEMPORAY COVER, THE DISTURBED AREA WILL BE MULCHED WITH STRAW, OR EQUIVALENT MATERIAL, AT A RATE OF TWO (2) TONS PER ACRE.
- ALL DISTURBED AREAS THAT ARE SUBJECT TO HIGH AMOUNTS OF EROSION (I.E. STEEP SLOPES, EMBANKMENTS GREATER THAN 3:1, OR OTHER AS DICTATED BY SITE CONDITIONS) MUST IMMEDIATELY RECEIVE A TEMPORARY SEEDING IN COMBINATION WITH MULCHING WITH STRAW, OR EQUIVALENT MATERIAL AT A THICKNESS OF TWO (2) TO
- FOUR (4) INCHES MIXED WITH THE TOP TWO (2) INCHES OF SOIL.
 ALL DISTURBED AREAS MUST, AS A MINIMUM, BE MAINTAINED BY WATER TO MINIMIZE THE GENERATION OF DUST.

- 1. THE SITE MUST, AT ALL TIMES, BE GRADED AND MAINTAINED SUCH THAT ALL STORM
- 1. HE SITE MUST, AT ALL IMES, BE ORACED AND MANTANES SUCH HIM ALL STORM MATER RINDERF IS CONTROLLED BY EROSION AND SEMILAR CONTROL MEASURES.

 2. ALL AREAS USED FOR MATERIAL STOCKPILE, BE IT FILL/EXCUNATED MATERIALS, STONE, OR OTHERMES, ARE TO BE STABULEZED, AND MUST HAVE SLIT FENCE INSTALLED PER THE DETAILS PROVIDED IN THE PLANS, OR BY EQUIVALENT MEASURES, AROUND THEIR DATINE DOWNGROUDE IN THE PLANS, OR BY EQUIVALENT MEASURES, AROUND THEIR DATINE DOWNGROUDE PERMITTED.

- INSTALLATION OF STORM SEWER AND UTILITIES

 1. TEMPORATY OUTLET PROJECTION MUST BE INSTALLED AT ALL PROPOSED STORM WATER
 OUTFALLS PROOF TO THE INSTALLATION OF THE DRAINAGE SYSTEM.

 2. ALL STIE DRAINAGE, INCLUDION ROOF DRAINS, DOWN SPOUTS, GUTTERS, OR OTHERWISE
 MUST BE ROUTLED TO CAMPER ALL STORM WATER TO THE PROPOSED STORM WATER
- MANAGEMENT SYSTEM(S).

 ANY SLOPES GREATER THAN 3:1 (H:V) RECEIVING PIPELINE OR UTILITY INSTALLATION MUST BE BACKFILLED AND STABILIZED DAILY AS THE INSTALLATION PROCEEDS.

- PERMANENT VEGETATION (I.E. SEED AND MULCH, SOD, ETC) TO BE INSTALLED ON ALL
- PENGMENT VEGETATION (LE. SEED AND MULCH, SUD, ELC) TO BE, INSTALLED ON ALL EXPOSED AREAS WITHIN TEN ILO) DAYS AFTER FINAL GRADING.

 UPON COMPETETION OF CONSTRUCTION, BUT PRIOR TO FINAL ACCEPTANCE, ALL CONSTRUCTION WASTE AND DEBRIS MUST BE REMOVED FROM THE SITE AND ALL PAYED ROUGHAYS AND/OR PARKING AREAS MUST BE SWEPT CLEAN OF ALL SEDIMENT.
- TEMPORARY EROSION AND SEDIMENT CONTROL MEASURES MUST REMAIN IN PLACE AND BE MAINTAINED UNTIL. SUCH TIME WHEN ALL UP-GRADE AREAS HAVE BEEN PERMANENTLY STABILIZED.



Addition 0 ō St, S Alabama 3 32565 <u>ō</u> 0 S S 13833 S / Jay, FL 3 Ø a

Revis	ion	
Dine	140.	Description
	\parallel	
_	H	
=	\blacksquare	
Drawn	Ву:	ASM
Check	ed By:	DPJj
Date:		August 1, 2018
Project No.:		170055
Пезия	no Tel	la:


Jay,

SITE EROSION CONTROL **DETAILS**

h jehle-halstead inc

C011

SITE EROSION CONTROL DETAILS

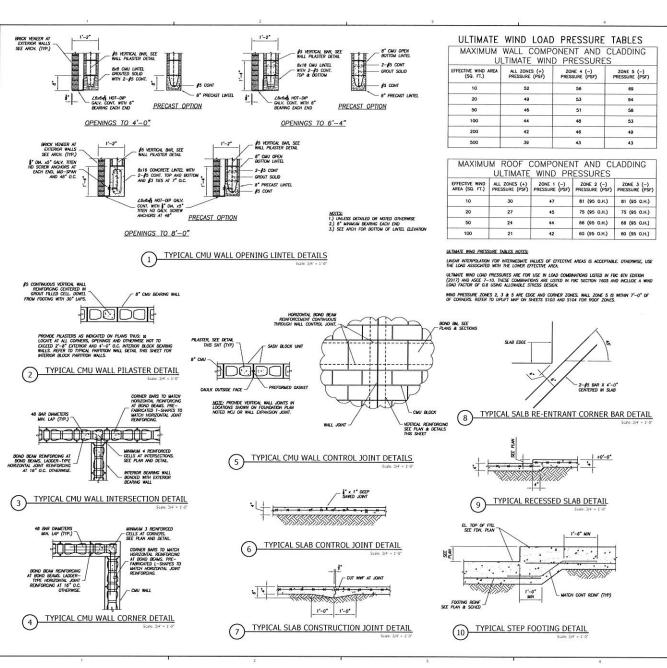

GENERAL NOTES:

CONCRETE CONCRETE BLOCK (CMU) BLOCK MORTAR BLOCK WALL GROUT REINF STEEL WELDED WIRE FABRIC STR STEEL (W)
STR STEEL (HSS)
MISC STR STEEL
ANCHOR BOLTS
LIGHT STEEL FRAG

ASTM C90 (f'm = 1,500 PSI) ASTM C270 TYPE S ASTM C476 (3,000 PSI) ASTM AB15 GRADE 60 ASTM A185 (FLAT SHEETS) ASTM 992 GR 50 ASTM A500 GR B ASTM A36 ASTM A36 ASTM A367 OR F1554, GR 36 ASTM A1003, STRUCTURAL GRADI

3,000 PSI AT 28 DAYS

STEEL ROOF DECK

3 -18 GA TRACK (3627125-43) 3 -18 GA STUD (3625162-43) 1) - 22 GAGE GALVANIZED TYPE B (MIDE RIB) RED HEAD TRUBOLT OR EQUIV. SIMPSON TITEN HD OR EQUIV.

BUILDING CODE 5TH EDITION 2014 AND MIND LOAD REQUIREMENTS PER ASCE

ULTIMATE DESIGN WIND SPEED = 150 MPH HOMINAL DESIGN WIND SPEED = 117 MPH BUILDING RISK CATEGORY II EXPOSURE CATEGORY C

ENCLOSED BUILDING (±0.18 INTERNAL PRESSURE COEFFICIENT) SEE DRAWINGS FOR COMPONENT & CLADDING PRESSURES

- 3. DESIGN ALLOWABLE SOIL BEARING PRESSURE IS 2,500 PSF. PREPARE SITE IN ACCORDANCE MITH THE GEOTECHNICAL ENGINEERING REPORT PREPARED BY UNIVERSAL ENGINEERING SCIENCES REPORT NO. 1592203 DATED
- 4. ALL ELEVATIONS REFERENCED ON THE STRUCTURAL DRAWINGS ARE ABOVE OR BELOW A FINISHED FLOOR ELEVATION OF +0'-0". SEE ARCHITECTURAL AND CML SITE GRADING PLAN FOR THE ACTUAL ELEVATION
- 5. PLACE REINFORCING IN CONCRETE WITH A MINIMUM OF 3" CLEAR COVER WHEN CAST AGAINST AND PERMANENTLY EXPOSED TO EARTH, PROVIDE CORNER BARS FOR ALL CONTINUOUS HORIZONTAL REINFORCING.
- 6. ADJUST FOOTING ELEVATIONS AS REQUIRED TO CLEAR DRAIN LINES.
- 7. FIELD VERIFY ALL EXISTING BUILDING DIMENSIONS SHOWN ON PLANS. ALSO SEE ARCHITECTURAL FOR DIMENSIONS AND COORDINATE.
- A REFERENCIED DENRIEDD COLD-FORMED WEIT, TRISCES SHUL DE DESDERD HI ACCOUNTAC WITH THE PROCED STEETS THOSE, LOOME REQUIREMENTS LISTE ON SEET STOE AND ARDCE ESTED WHO LOO-CRITEM PER THE FLOREN BALBING COS BHI EDTING LOOT). TRISCS MANUFACTURET SHUL PROCKE A ECTAL FOR NECESSARY FEED INSTITULED SHOCKAT FOR CONCOMINGTE LOOKS FAMELD AND THOSE MOST PARTIES PROCKAT FOR CONCOMINGTO, AND ART OF THE ARTHONIS FAMEL MORNING TOR REVIEW FROM TO FARRESTATION. SHOP DEBUNGS, SHUL HILLIER TRISCS LOOKS, TRUST SEETLY, AND SHUL PROCKE ALL CONNECTIONS AND BROCKES SHUL IES GOES MANUFACIONES. TRUST SHOW ALL CONNECTIONS SHUL PROCKE BLOCKING TOWN IN OUR TO TRUSTS TOP CHOICE AND DETERMINED SHUL PROCKE BLOCKING TOWN IN OUR TO TRUST TOP CHOICE AND DETERMINED. SHUL PROCKE BLOCKING TOWN IN OUR TO TRUST TOP CHOICE AND DETERMINED. SHUL PROCKE BLOCKING TOWN IN OUR TO TRUST TOP CHOICE AND DETERMINED. SHUL PROCKE BLOCKING TOWN IN OUR TO TRUST TOP CHOICE AND DETERMINED. SHUL PROCKE BLOCKING TOWN IN OUR TO TRUST TOP CHOICE AND DETERMINED. SHULL PROCKE BLOCKING TOWN IN OUR TO TRUST TOP CHOICE AND DETERMINED. SHULL PROCKE SHULL BE AS ESTALD ON THE STRUCTURAL DRIVENESS. AND DRIVEN SHULL BE AS ESTALD ON THE STRUCTURAL DRIVENESS. A PREFARRICATED ENGINEERED COLD-EDRUGD METAL TRICSES SHALL BE



OMERGE OF RETURNING OF SERVICE ALL REPORTS, PLANS, SECENCIATIONS, CONFUTER FLESS, FELD DA MOTES AND CONFERCOCLABIES AND INSTRACING SERVICES SIN THE COMBILLY AND INSTRUMENTS OF SERVICE SAVING REPORTS SECENCIATOR OF THE CONDUCTIONS OF THE CONDUCTIONS SAVIL RETURNS.

CONSTRUCTION DOCUMENTS

(PHASE III)

Addition ementa STOOM 32565 Ш S S 13833 S Jay, FL Cla

Drawn By: SWI Checked By: BLSE Project No.: 17052 GENERAL NOTES AND TYPICAL DETAILS


Date: No.


STRUCTURES

BERUBE LEONARD LLC

Stephen W. Leonard, PE (Fl. Ltc. No. 80370

Drawing No.: S001

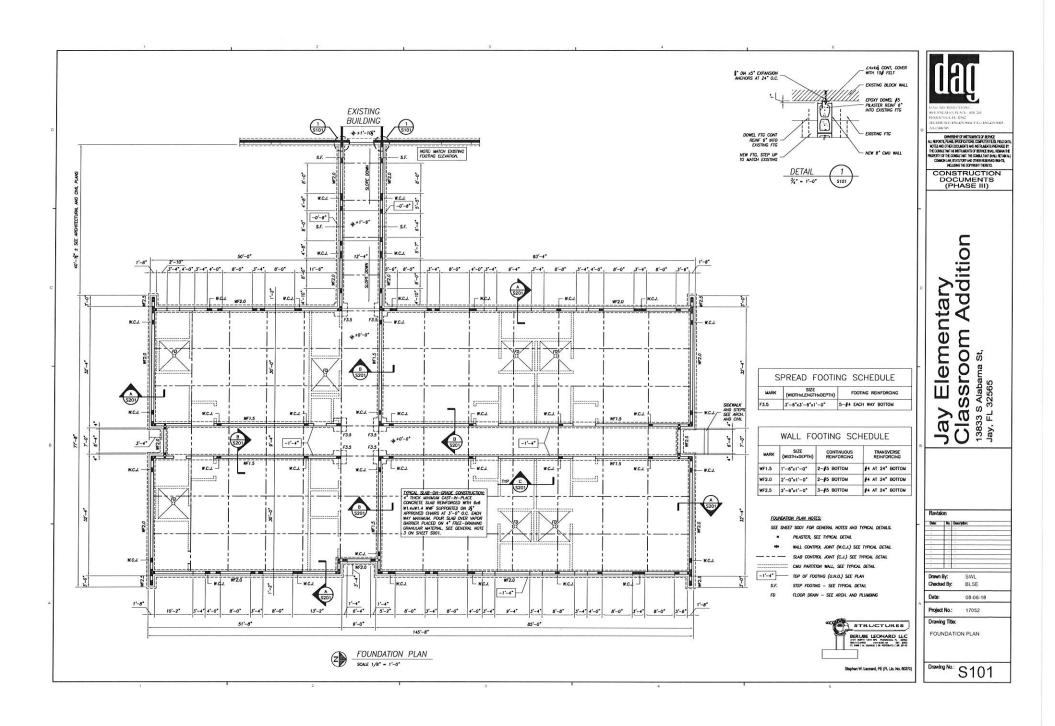

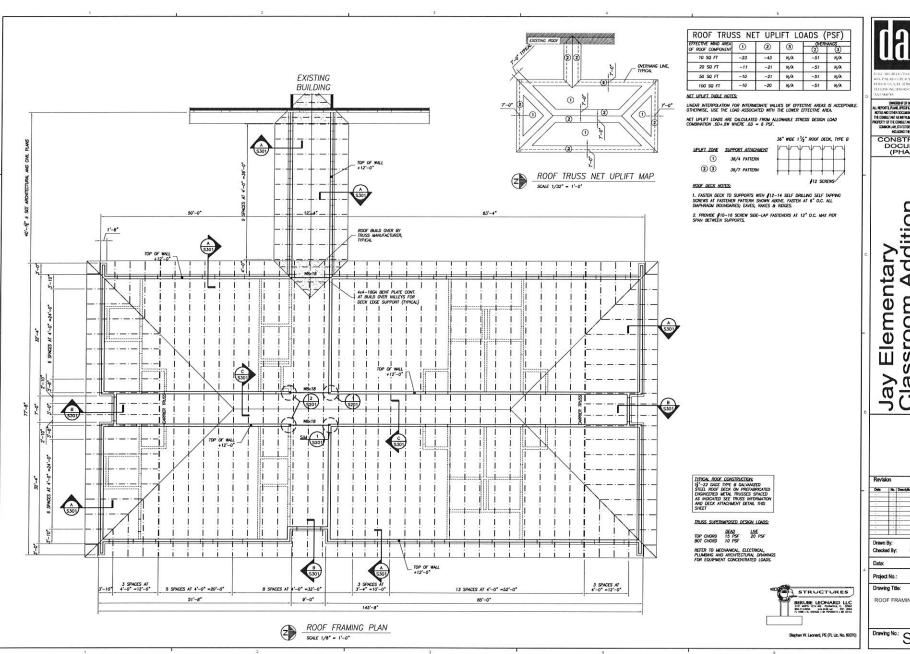



OMERGE OF RETURNING OF SEALS
ALL REPORTS, RAMS, RECEIPCINGS, COMPUTER THE PRED DAYS
THE COMMUNICATION OF RETURNING PRED DAYS
THE COMMUNICATION OF RETURNING OF REPORTS OF THE COMMUNICATION OF THE COM

CONSTRUCTION DOCUMENTS (PHASE III)

Addition Elementary S Alabama St, 13833 S Alabama Jay, FL 32565 ay


Revision

17052

Drawing Title:

ROOF FRAMING PLAN

Drawing No.: S102

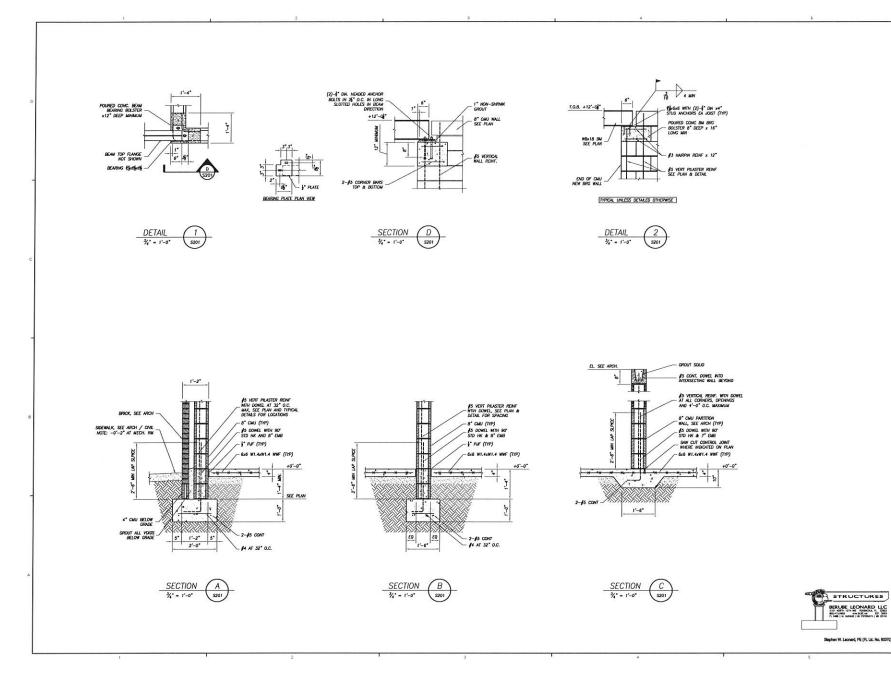

Jay Elementary Classroom Addition

Dela: No. Descr

Drawn By:

Date: 08-06-1
Project No.: 17052

Checked By:

Drawing Title:

SWL

BLSE

SECTIONS AND DETAILS

Drawing No.: S201

OMERSE OF INTERMENT OF ERRORS
ALL RECKEL, RAME, RECKELLOND, COMPITER FLEE, RELD ONL
THE COMMITTER ALL RECKELLOND, COMPITER FLEE, RELD ONL
THE COMMITTER ALL RECKELLOND AND REVISION FROM THE RECKELLOND AND RECKELLOND AND RECKELLOND AND RECKELLOND AND RESIDENCE PROPERTY.
NOLLENG THE COMPITION AND OTHER PERSONS PROPERTY.
NOLLENG THE COMPITION THE PERSONS PROPERTY.

CONSTRUCTION DOCUMENTS (PHASE III)

