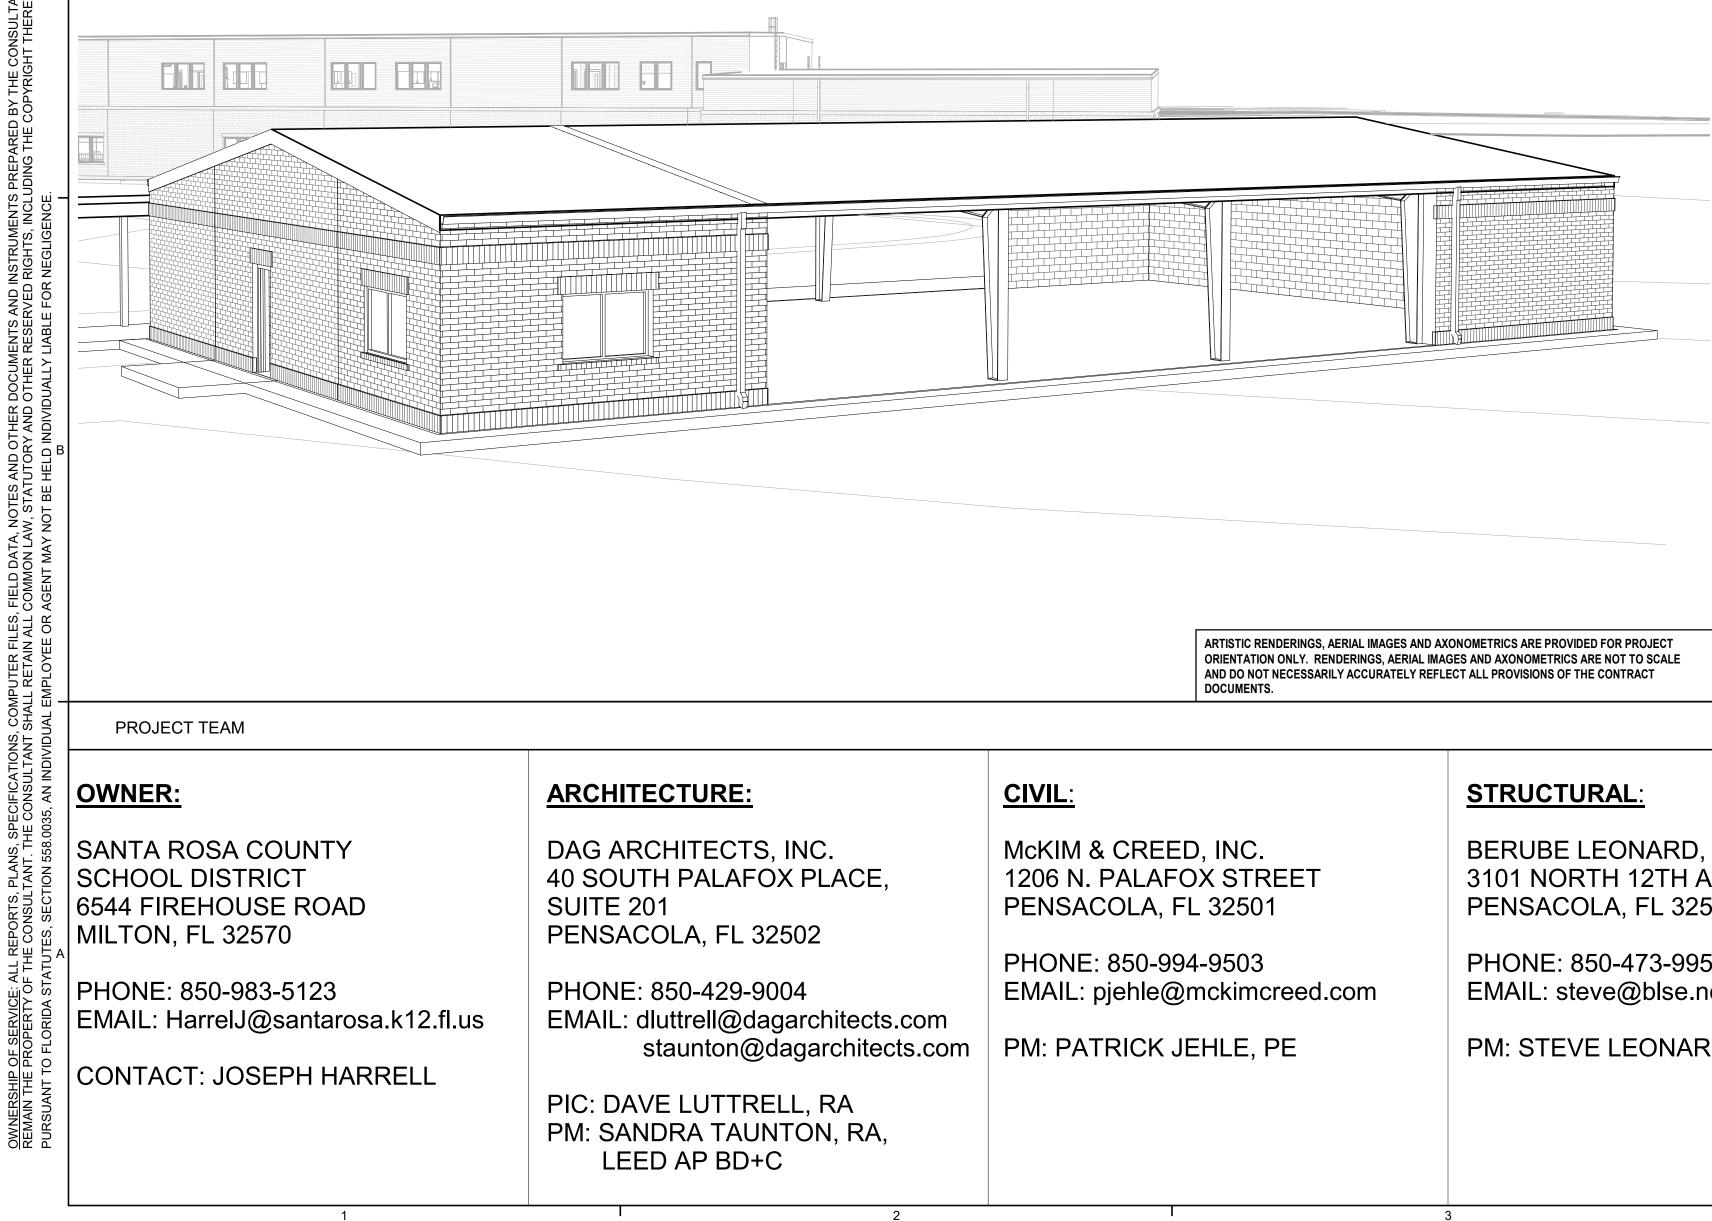
2005 PHASE I

SANTA ROSA COUNTY SCHOOL DISTRICT

COVERED PE BUILDING for EAST BAY K-8 SCHOOL

2535 ELKHART DRIVE, **GULF BREEZE, FL 32563**





BERUBE LEONARD, LLC 3101 NORTH 12TH AVENUE PENSACOLA, FL 32503

PHONE: 850-473-9955 EMAIL: steve@blse.net

PM: STEVE LEONARD, PE

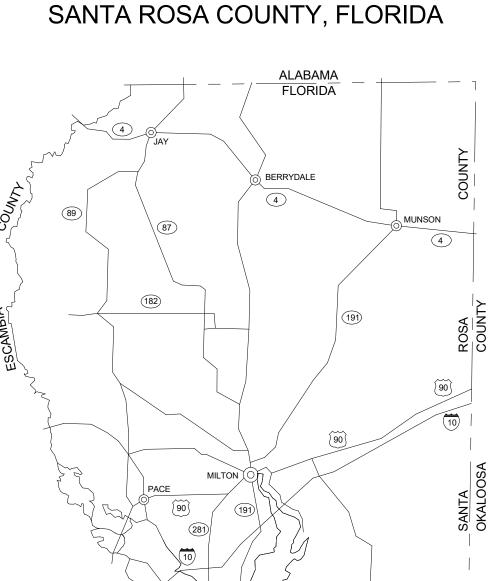
PROJECT SCOPE

PROJECT CONSISTS OF 1 STORY COVERED PLAY BUILDING.

APPLICABLE CODES

Florida Building Code (FBC), Sixth Edition (2017) Florida Fire Prevention Code, Sixth Edition (2017) NFPA 1 Fire Code and NFPA 101 Life Safety Code 2015 Edition Florida Plumbing Code, Sixth Edition (2017) Florida Mechanical Code, Sixth Edition (2017 Florida Fuel Gas Code, Sixth Edition (2017) National Electrical Code, NFPA 70, 20008 Editio Florida Energy Code (FEC), Sixth Edition (2017) Florida Accessibility Code, Sixth Edition (2017

PROJECT LOCATION



87 PROJECT LOCATION: ELKHART K8

ELKHART DRIVE GULF BREEZE, FL 32563

MECHANICAL / PLUMBING / TELECOM:

SCHMIDT CONSULTING GROUP, INC. 901 WEST GARDEN STREET PENSACOLA, FL 32502

PHONE: 850-438-0050 EMAIL: joe@schmidtconsultinggroup.com

PM: JOE JONES, PE

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	X OF DRAWINGS
SHEET NUMBER	SHEET TITLE
P101	SANITARY PLAN
P102	DOMESTIC WATER PLAN
S000	OPENING PAGE
S001	GENERAL NOTES & TYPICAL DETAILS
S101	FOUNDATION PLAN AND SECTION DETAILS
GENERAL	
G000	COVER SHEET
SN (11	
C000	NOTES AND INFORMATION
C100	DEMOLITION AND EROSION CONTROL PLAN
C200	SITE IMPROVEMENTS PLAN
C200	GRADING PLAN
C300	DRAINAGE & UTILITY PLAN
C400	SITE DETAILS
C900 C910	EROSION CONTROL DETAILS
0310	
RCHITECTU	RAL
A001	ABBREVIATIONS & SYMBOLS
A100	ARCHITECTURAL SITE PLAN
A101	FLOOR PLAN & DIMENSION PLAN
A102	REFLECTED CEILING PLAN AND FINISHES
A200	BUILDING ELEVATIONS & SECTIONS
A310	WALL SECTIONS AND DETAILS
A600	DOOR AND FRAME SCHEDULE
/IECHANICAL	
M001	MECHANICAL LEGEND
M001 M002	MECHANICAL LEGEND MECHANICAL SCHEDULES
M1002	MECHANICAL SCHEDULES
IVI I UU	
MEOO	MECHANICAL DETAILS
M500	
M501	MECHANICAL DETAILS
	MECHANICAL DETAILS MECHANICAL CONTROLS
M501	
M501 M600	
M501 M600 ELECTRICAL	MECHANICAL CONTROLS
M501 M600 ELECTRICAL E001	MECHANICAL CONTROLS
M501 M600 ELECTRICAL E001 E002	MECHANICAL CONTROLS ELECTRICAL LEGEND, NOTES, ABBREVIATIONS ELECTRICAL LIGHTING FIXTURE SCHEDULE
M501 M600 ELECTRICAL E001 E002 E100	MECHANICAL CONTROLS ELECTRICAL LEGEND, NOTES, ABBREVIATIONS ELECTRICAL LIGHTING FIXTURE SCHEDULE ELECTRICAL SITE PLAN
M501 M600 ELECTRICAL E001 E002 E100 E200	MECHANICAL CONTROLS ELECTRICAL LEGEND, NOTES, ABBREVIATIONS ELECTRICAL LIGHTING FIXTURE SCHEDULE ELECTRICAL SITE PLAN FIRST FLOOR OVERALL LIGHTING PLAN
M501 M600 ELECTRICAL E001 E002 E100 E200 E201	MECHANICAL CONTROLS ELECTRICAL LEGEND, NOTES, ABBREVIATIONS ELECTRICAL LIGHTING FIXTURE SCHEDULE ELECTRICAL SITE PLAN FIRST FLOOR OVERALL LIGHTING PLAN FIRST FLOOR LIGHTING
M501 M600 ELECTRICAL E001 E002 E100 E200 E201 E301	MECHANICAL CONTROLS ELECTRICAL LEGEND, NOTES, ABBREVIATIONS ELECTRICAL LIGHTING FIXTURE SCHEDULE ELECTRICAL SITE PLAN FIRST FLOOR OVERALL LIGHTING PLAN FIRST FLOOR LIGHTING FIRST FLOOR POWER - AREA A
M501 M600 ELECTRICAL E001 E002 E100 E200 E201 E301 E401 E601	MECHANICAL CONTROLS ELECTRICAL LEGEND, NOTES, ABBREVIATIONS ELECTRICAL LIGHTING FIXTURE SCHEDULE ELECTRICAL SITE PLAN FIRST FLOOR OVERALL LIGHTING PLAN FIRST FLOOR LIGHTING FIRST FLOOR LIGHTING FIRST FLOOR SYSTEMS - AREA A ELECTRICAL DETAILS
M501 M600 ELECTRICAL E001 E002 E100 E200 E201 E301 E401 E601 E602	MECHANICAL CONTROLS ELECTRICAL LEGEND, NOTES, ABBREVIATIONS ELECTRICAL LIGHTING FIXTURE SCHEDULE ELECTRICAL SITE PLAN FIRST FLOOR OVERALL LIGHTING PLAN FIRST FLOOR LIGHTING FIRST FLOOR LIGHTING FIRST FLOOR POWER - AREA A FIRST FLOOR SYSTEMS - AREA A ELECTRICAL DETAILS ELECTRICAL DETAILS
M501 M600 ELECTRICAL E001 E002 E100 E200 E201 E301 E401 E601 E602 E603	MECHANICAL CONTROLS ELECTRICAL LEGEND, NOTES, ABBREVIATIONS ELECTRICAL LIGHTING FIXTURE SCHEDULE ELECTRICAL SITE PLAN FIRST FLOOR OVERALL LIGHTING PLAN FIRST FLOOR LIGHTING FIRST FLOOR POWER - AREA A FIRST FLOOR SYSTEMS - AREA A ELECTRICAL DETAILS ELECTRICAL DETAILS
M501 M600 ELECTRICAL E001 E002 E100 E200 E201 E301 E401 E601 E602 E603 E603 E604	MECHANICAL CONTROLS ELECTRICAL LEGEND, NOTES, ABBREVIATIONS ELECTRICAL LIGHTING FIXTURE SCHEDULE ELECTRICAL SITE PLAN FIRST FLOOR OVERALL LIGHTING PLAN FIRST FLOOR LIGHTING FIRST FLOOR POWER - AREA A FIRST FLOOR SYSTEMS - AREA A ELECTRICAL DETAILS ELECTRICAL DETAILS ELECTRICAL DETAILS
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M501 M600 ELECTRICAL E001 E002 E100 E200 E201 E301 E401 E601 E602 E603 E604 E605 E608	MECHANICAL CONTROLSELECTRICAL LEGEND, NOTES, ABBREVIATIONSELECTRICAL LIGHTING FIXTURE SCHEDULEELECTRICAL SITE PLANFIRST FLOOR OVERALL LIGHTING PLANFIRST FLOOR LIGHTINGFIRST FLOOR POWER - AREA AFIRST FLOOR SYSTEMS - AREA AELECTRICAL DETAILSELECTRICAL DETAILS
M501 M600 ELECTRICAL E001 E002 E100 E200 E201 E301 E401 E601 E602 E603 E603 E604 E605 E608 E608 E609	MECHANICAL CONTROLSELECTRICAL LEGEND, NOTES, ABBREVIATIONSELECTRICAL LIGHTING FIXTURE SCHEDULEELECTRICAL SITE PLANFIRST FLOOR OVERALL LIGHTING PLANFIRST FLOOR LIGHTINGFIRST FLOOR LIGHTINGFIRST FLOOR SYSTEMS - AREA AELECTRICAL DETAILSELECTRICAL DETAILS
M501 M600 ELECTRICAL E001 E002 E100 E200 E201 E301 E401 E601 E602 E603 E604 E605 E608	MECHANICAL CONTROLSELECTRICAL LEGEND, NOTES, ABBREVIATIONSELECTRICAL LIGHTING FIXTURE SCHEDULEELECTRICAL SITE PLANFIRST FLOOR OVERALL LIGHTING PLANFIRST FLOOR LIGHTINGFIRST FLOOR POWER - AREA AFIRST FLOOR SYSTEMS - AREA AELECTRICAL DETAILSELECTRICAL DETAILS

ELECTRICAL:

SCHMIDT CONSULTING GROUP, INC. 901 WEST GARDEN STREET PENSACOLA, FL 32502

PHONE: 850-438-0050 EMAIL: toddn@schmidtconsultinggroup.com

PM: TODD NICHOLSON, PE

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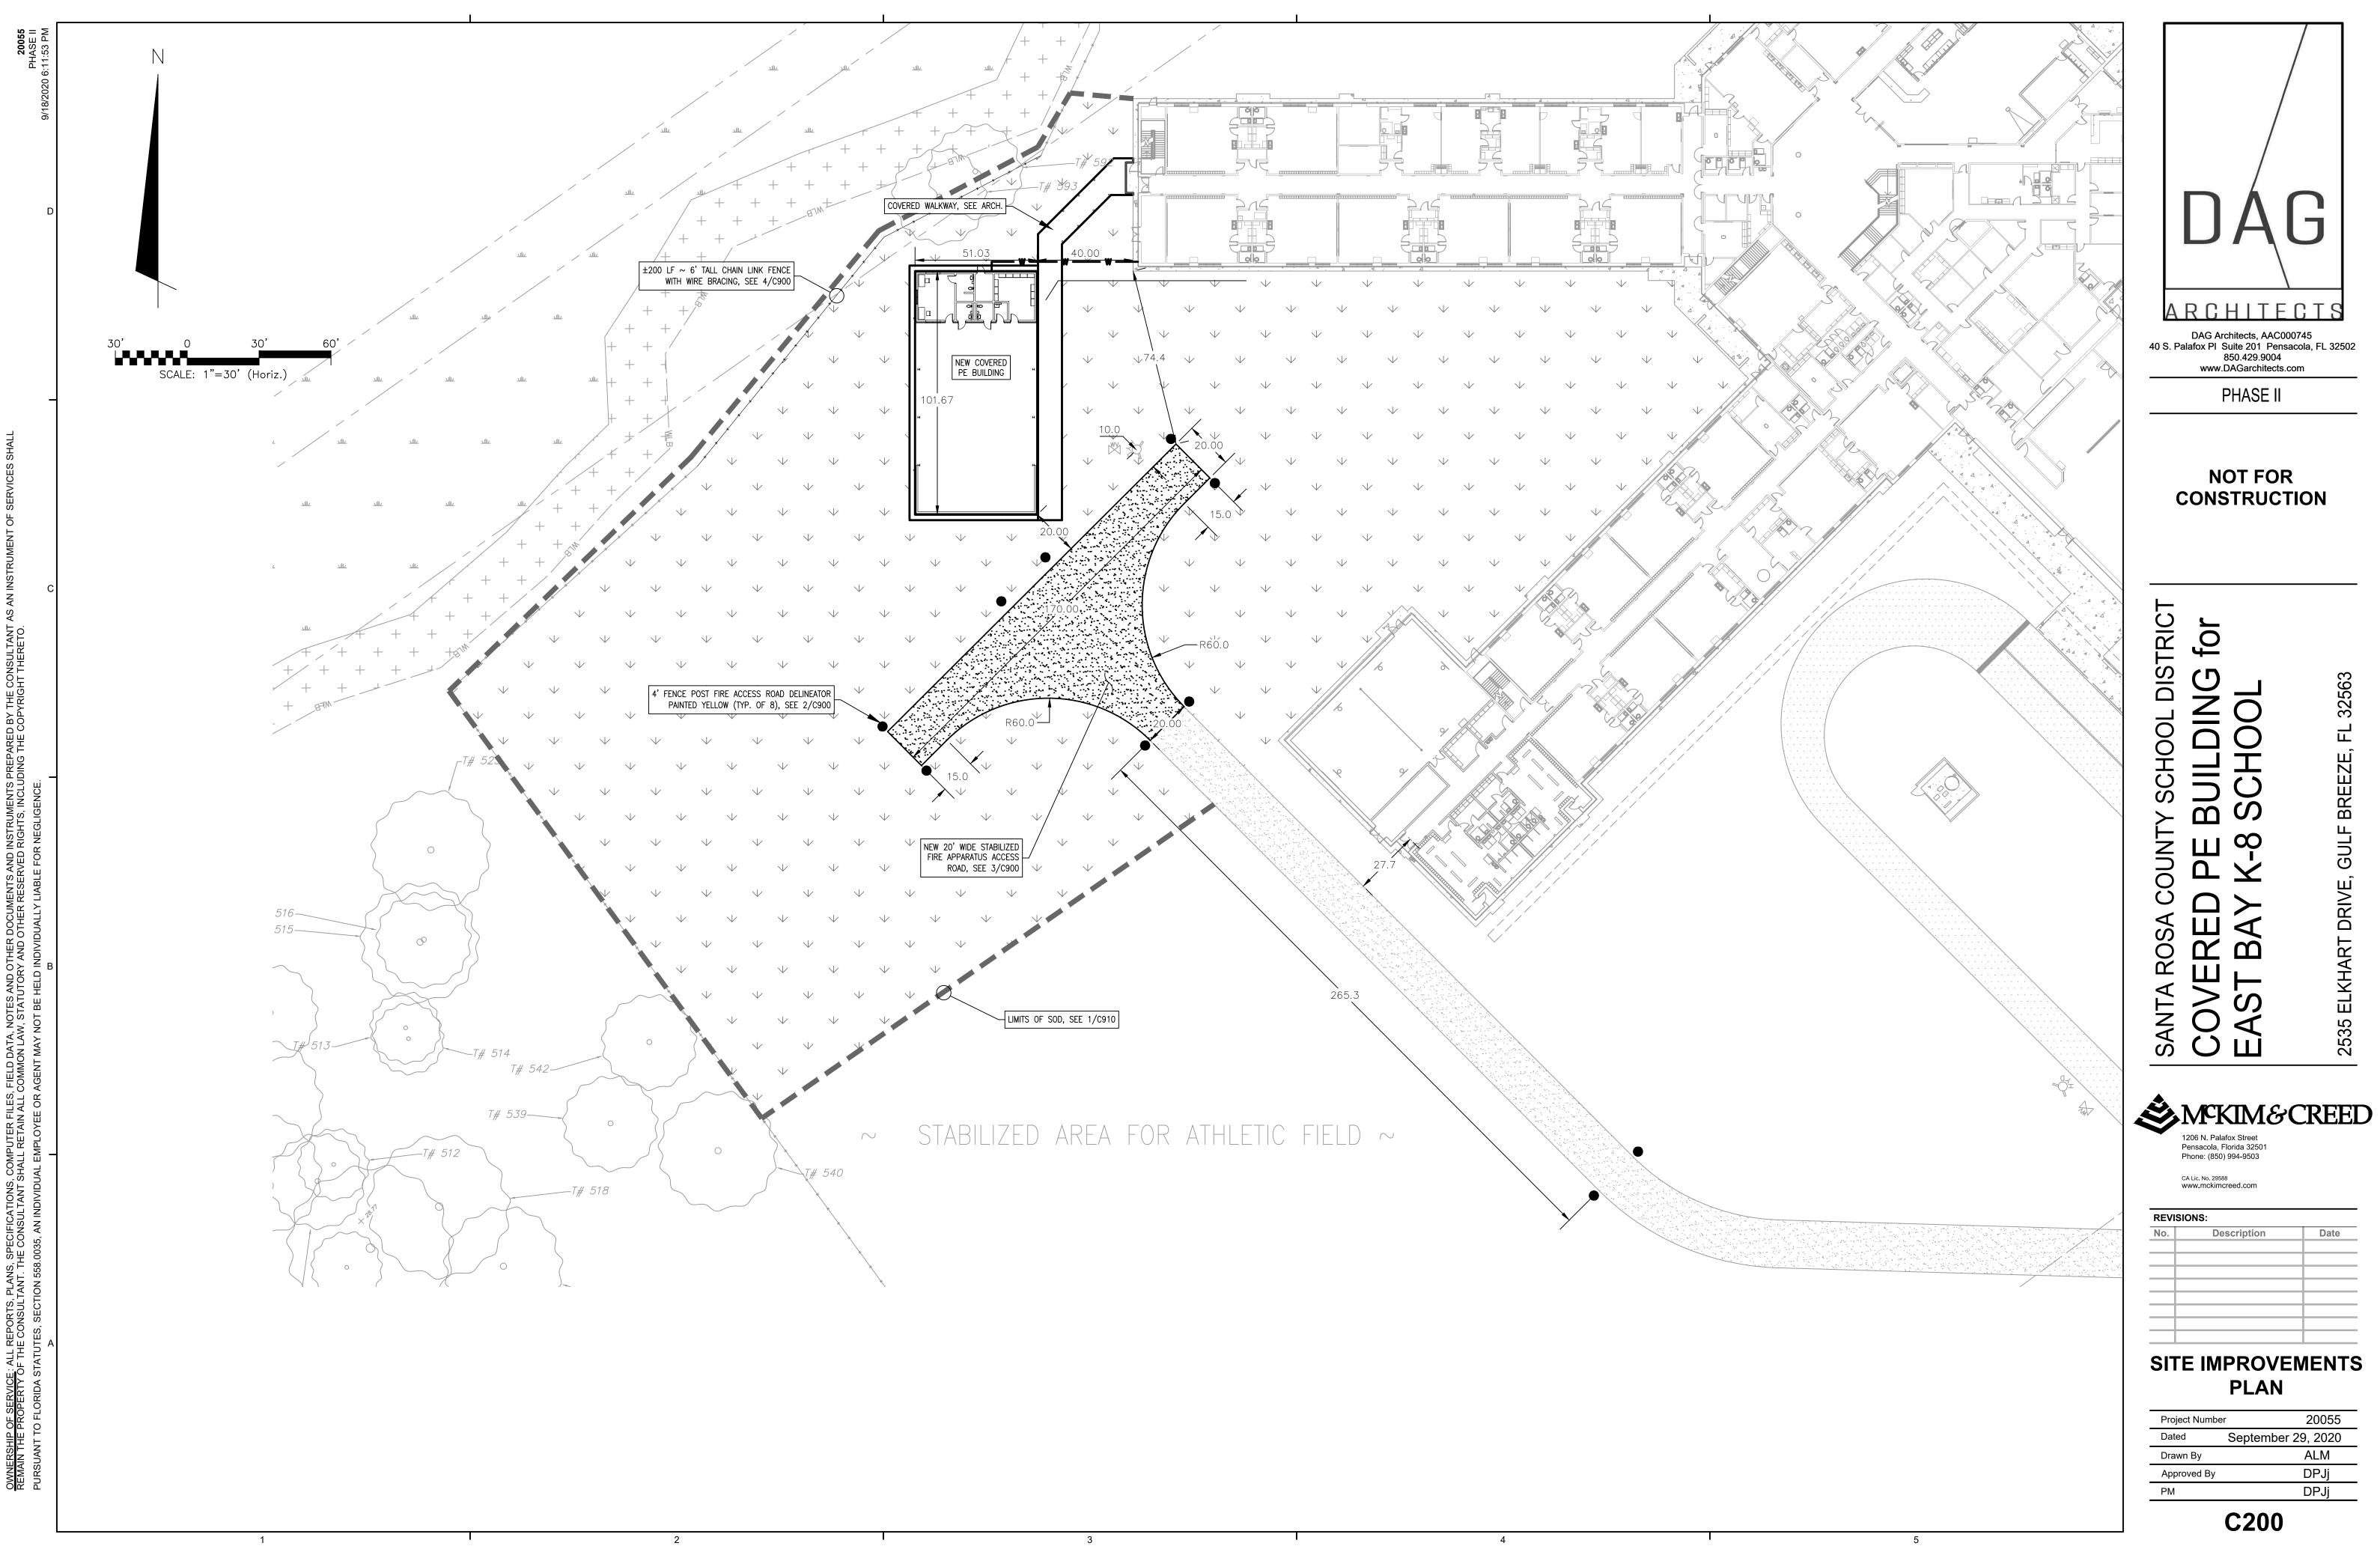
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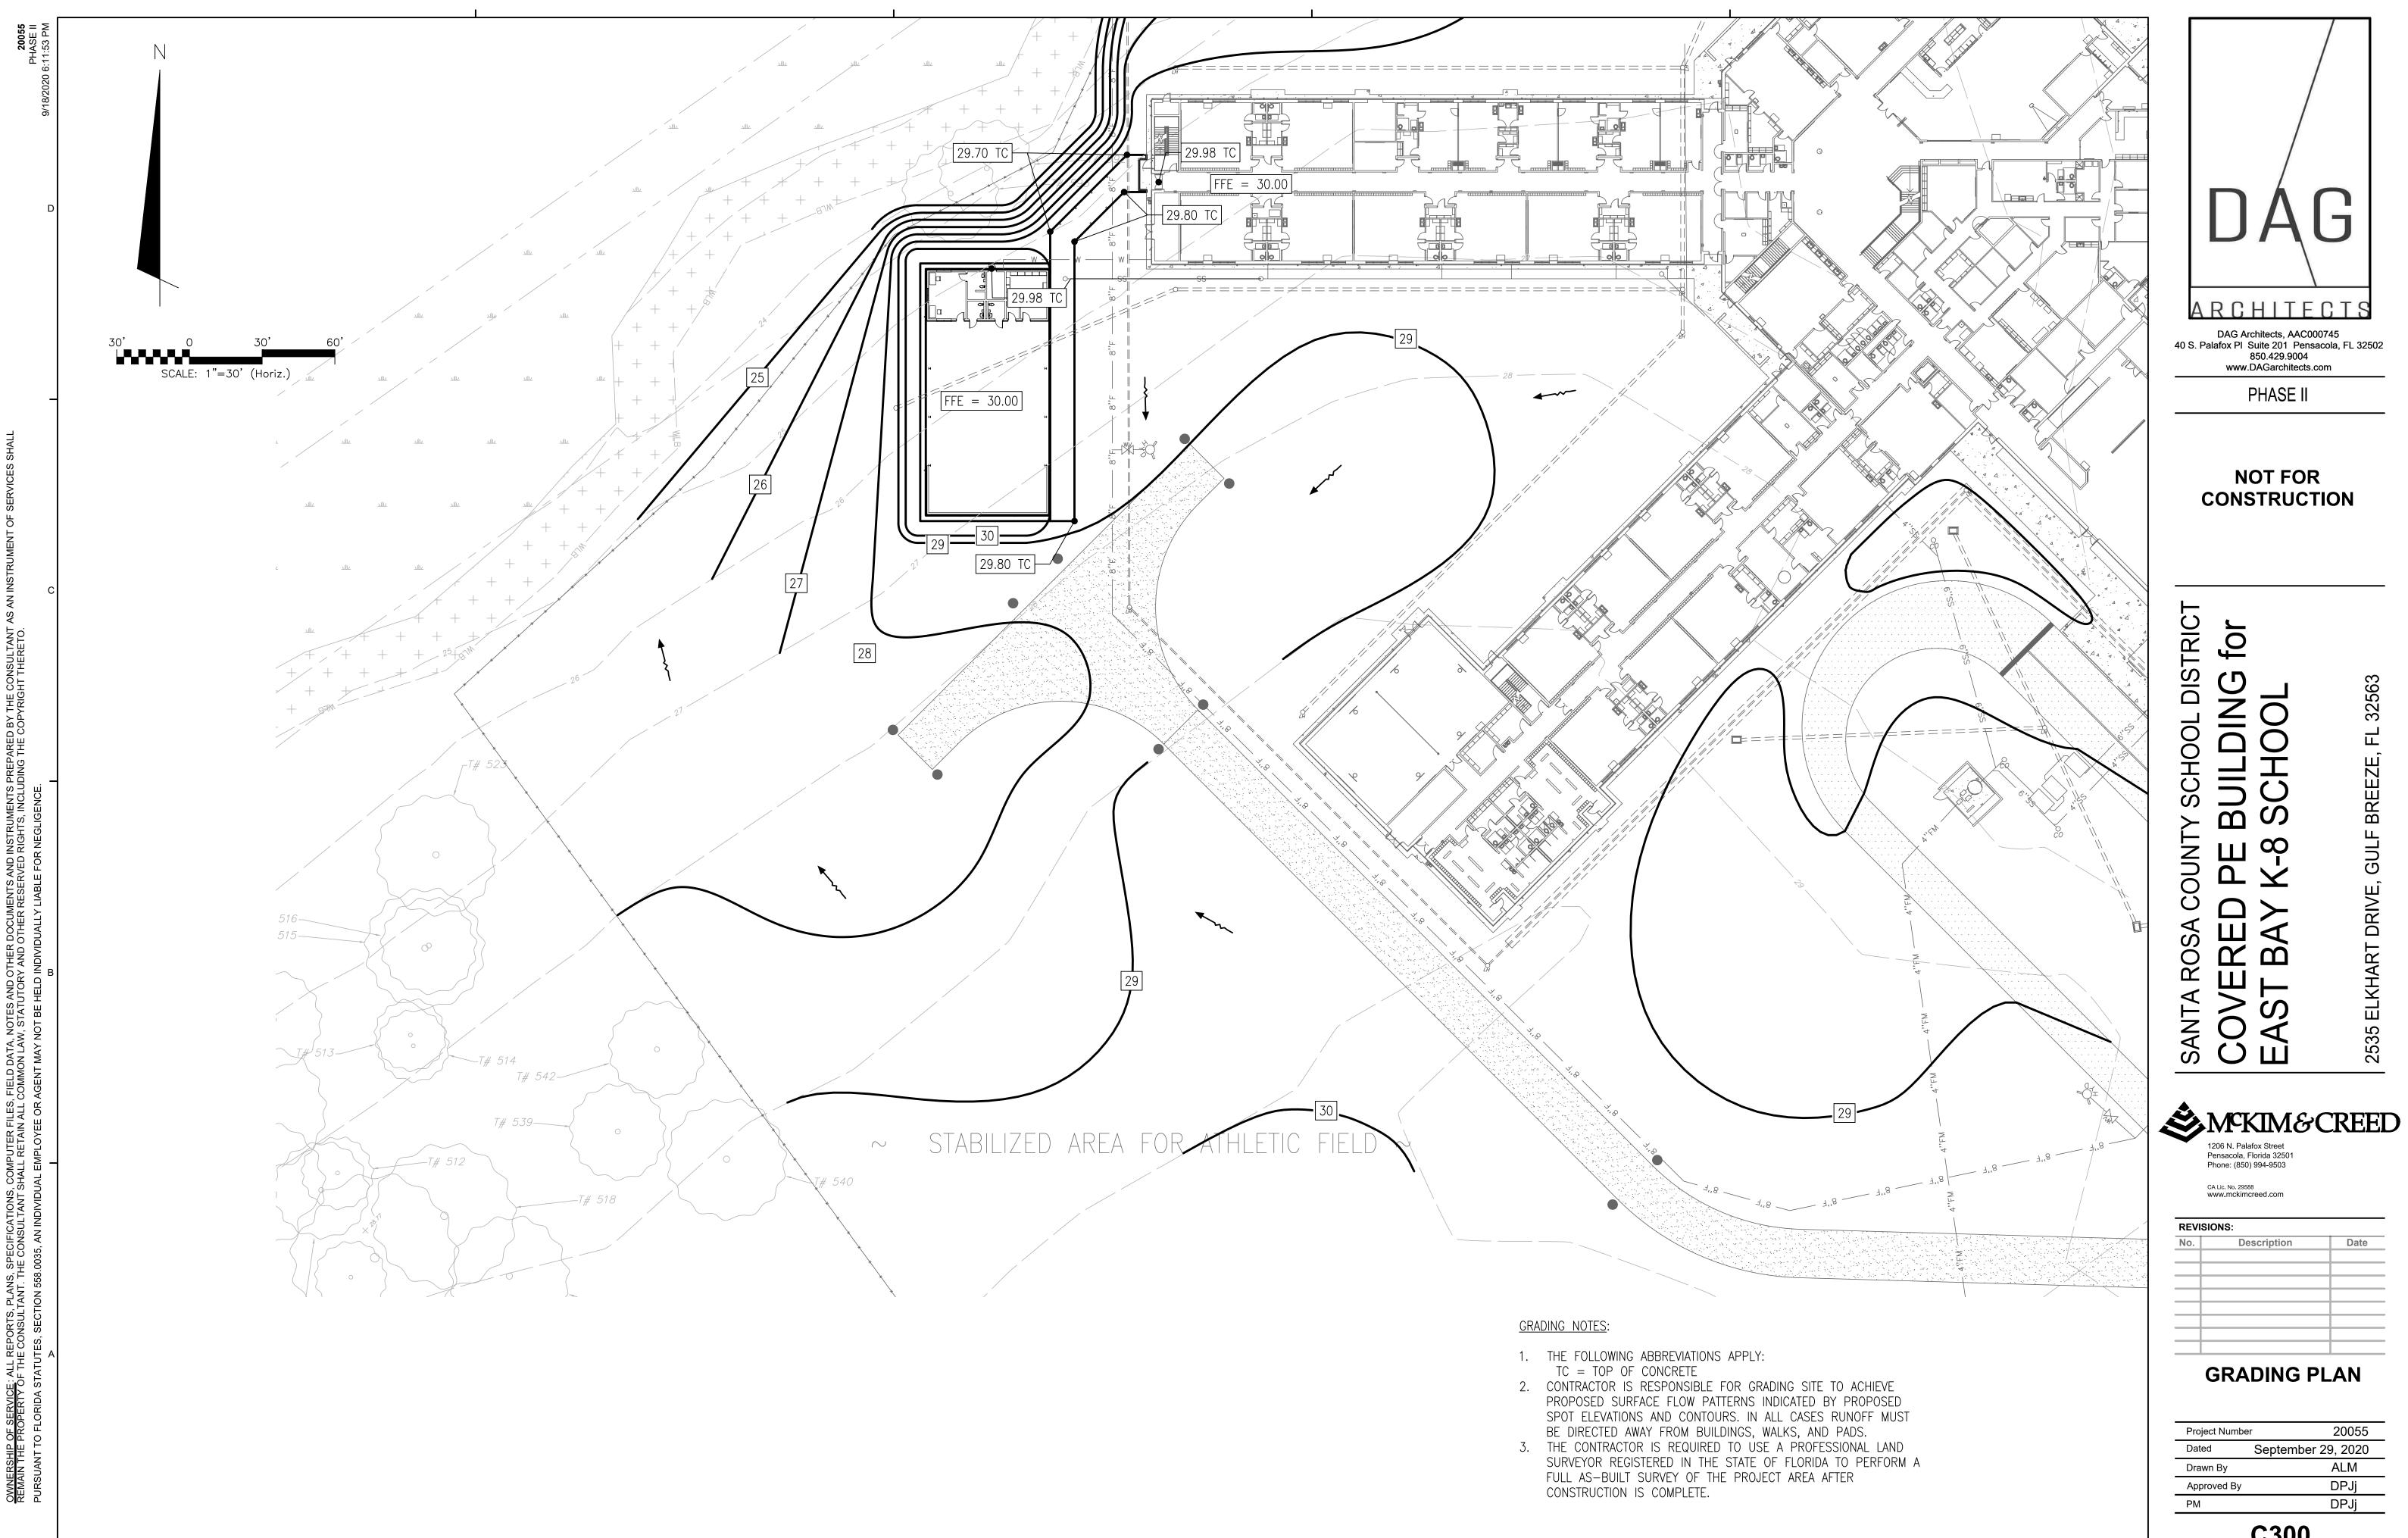


REVISIONS:										
No.	Description	Date								

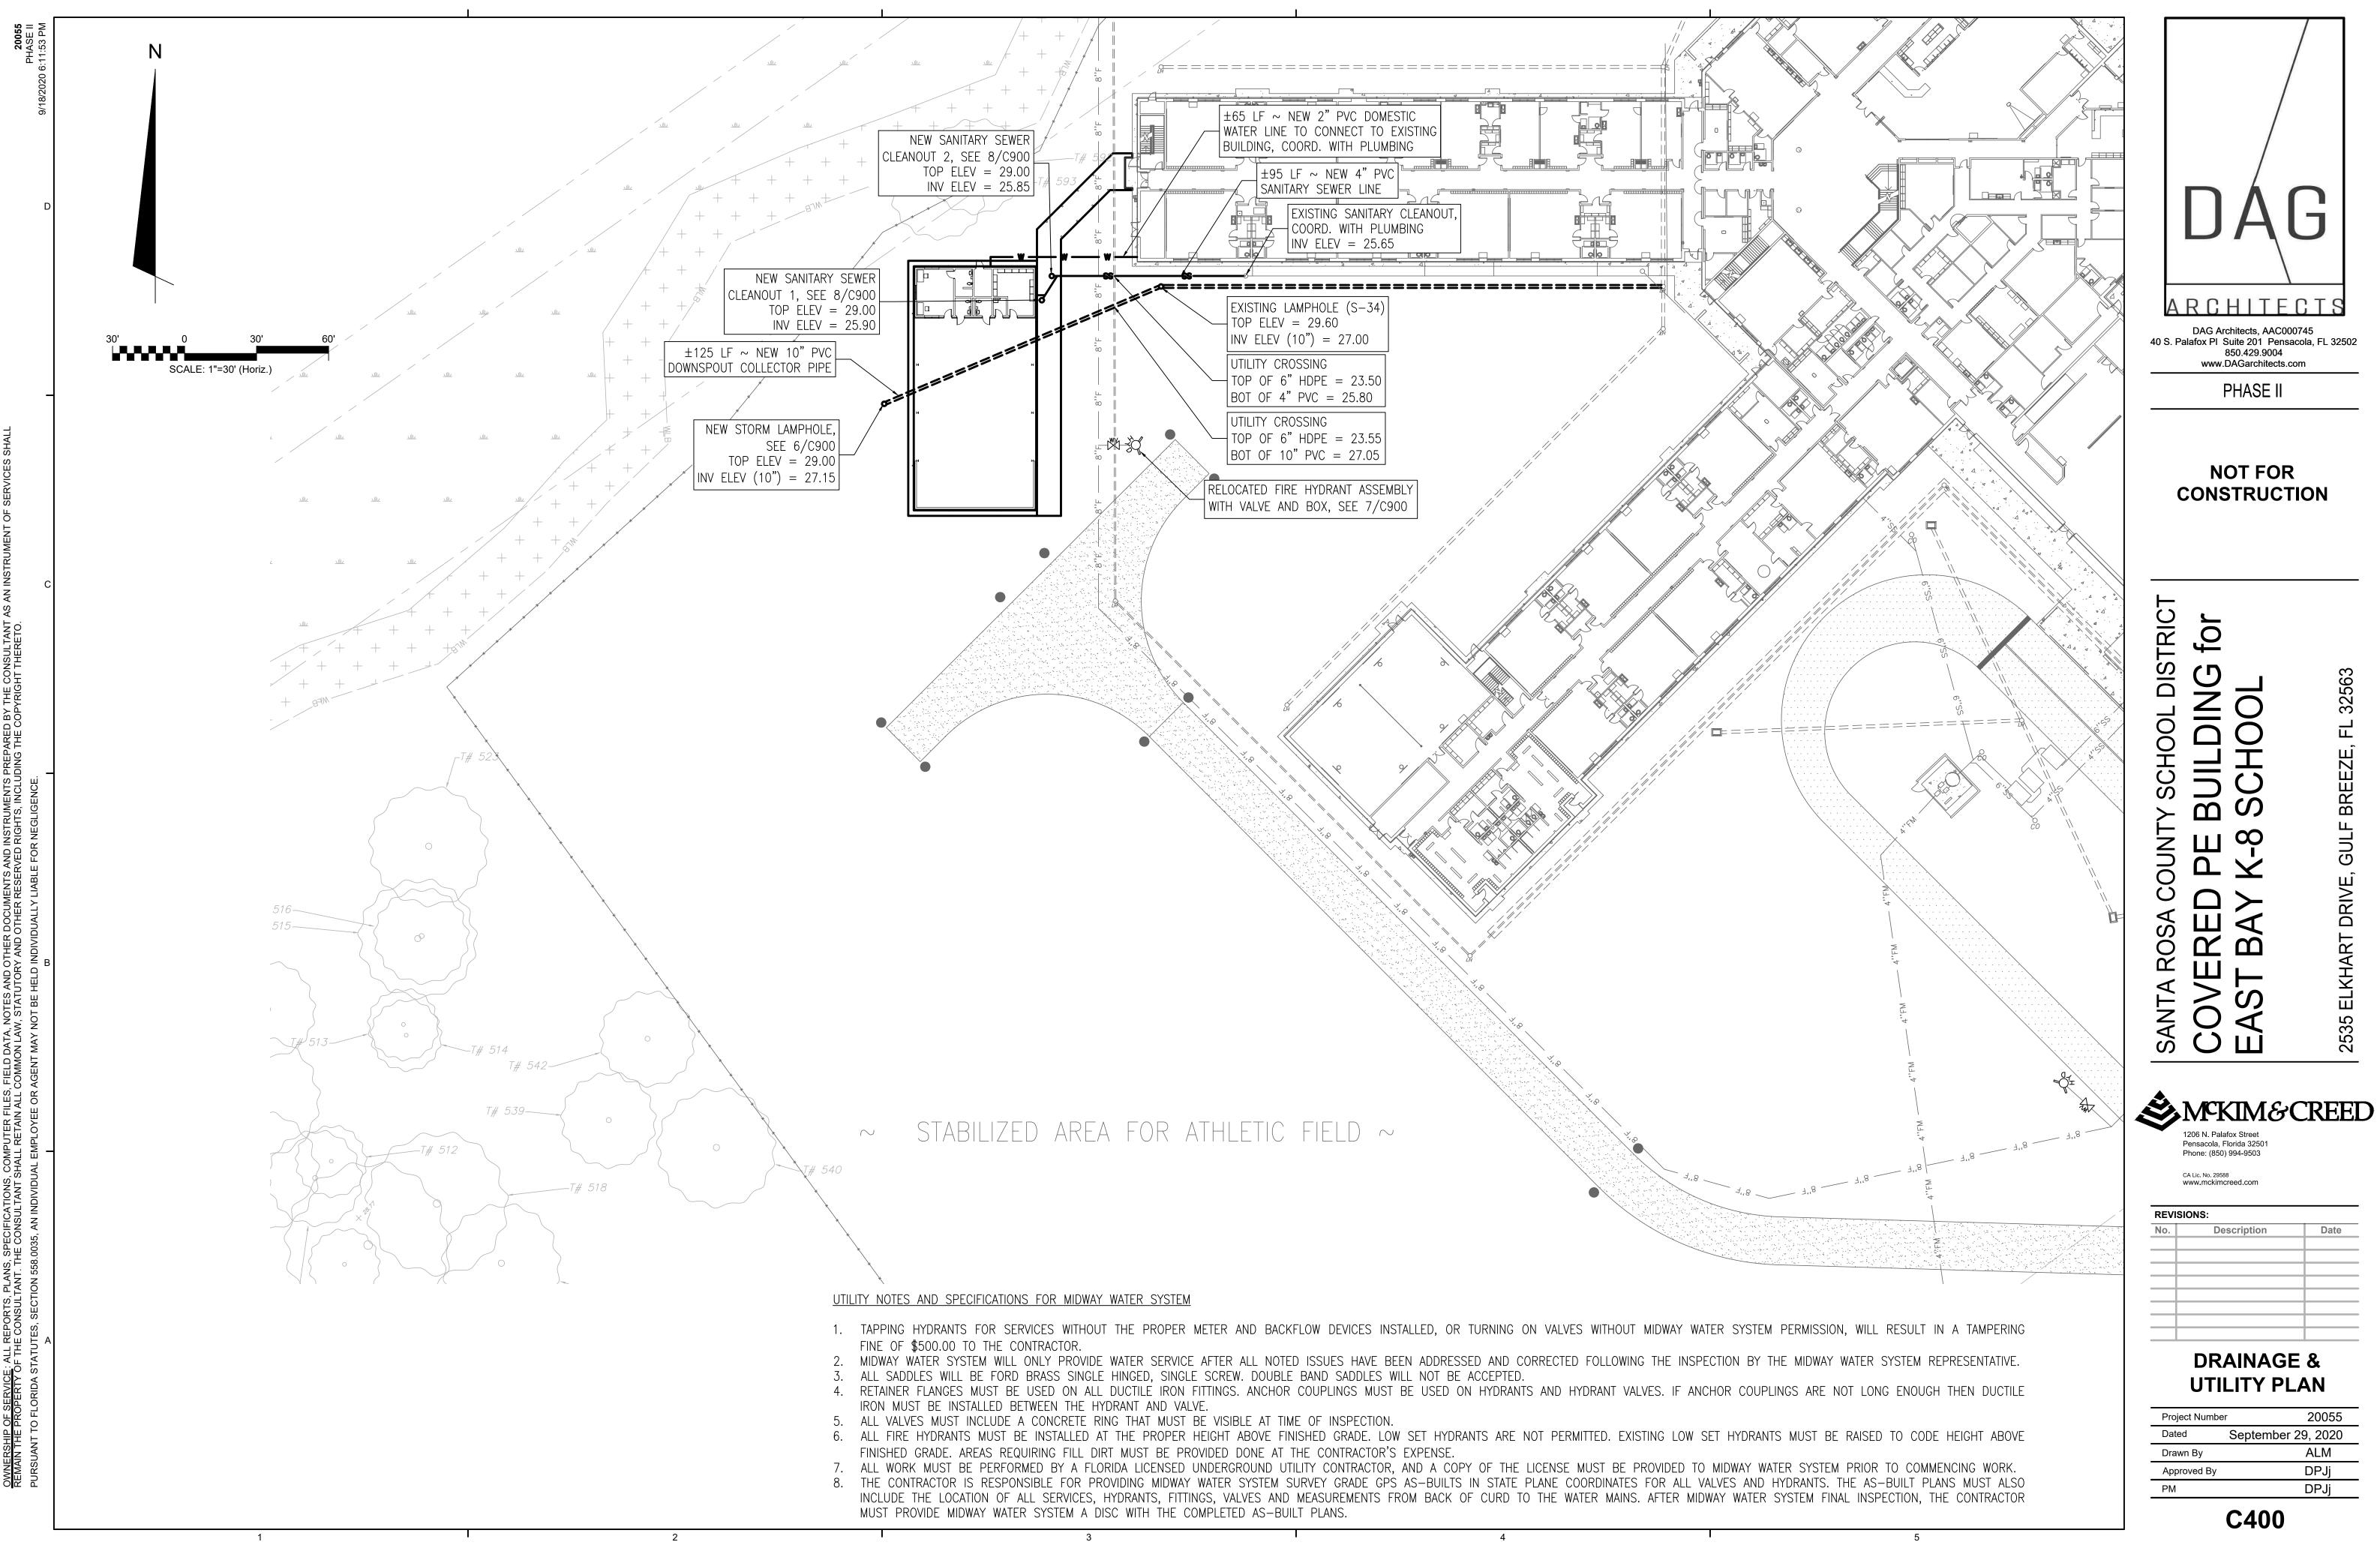
COVER SHEET

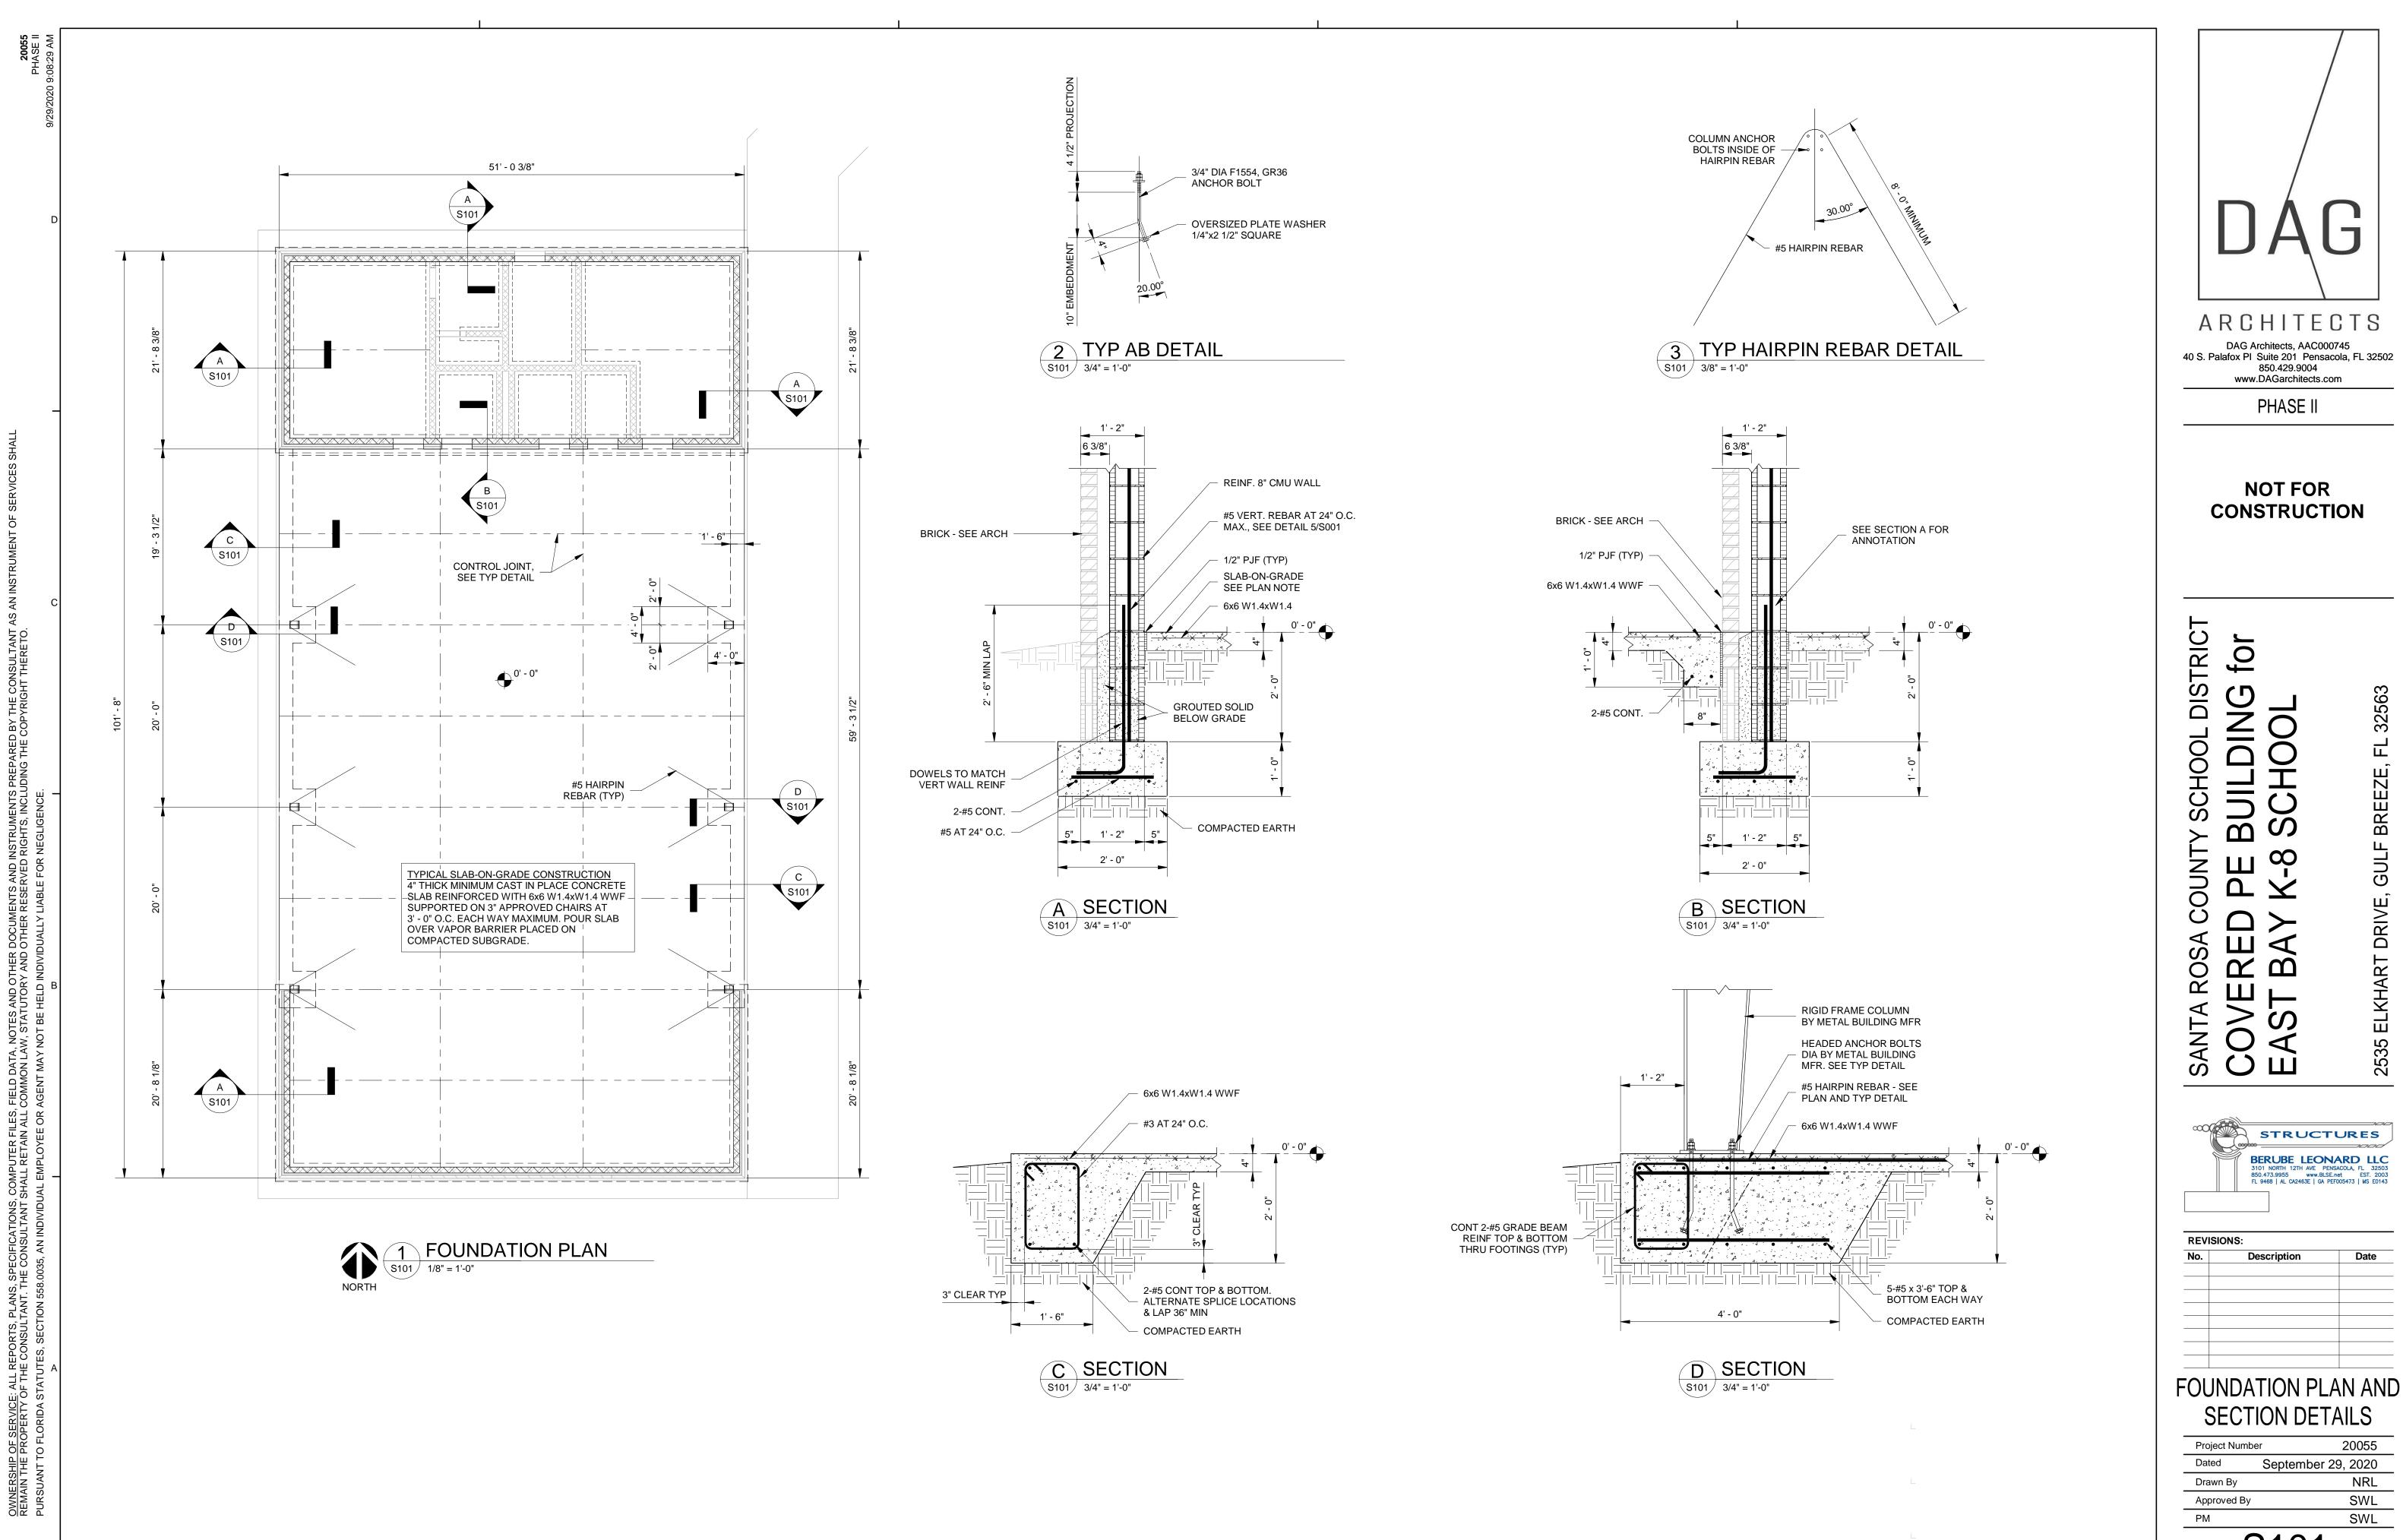
Project Num	ber 20055
Dated	September 29, 2020
Drawn By	Author
Approved By	Approver
PM	Designer
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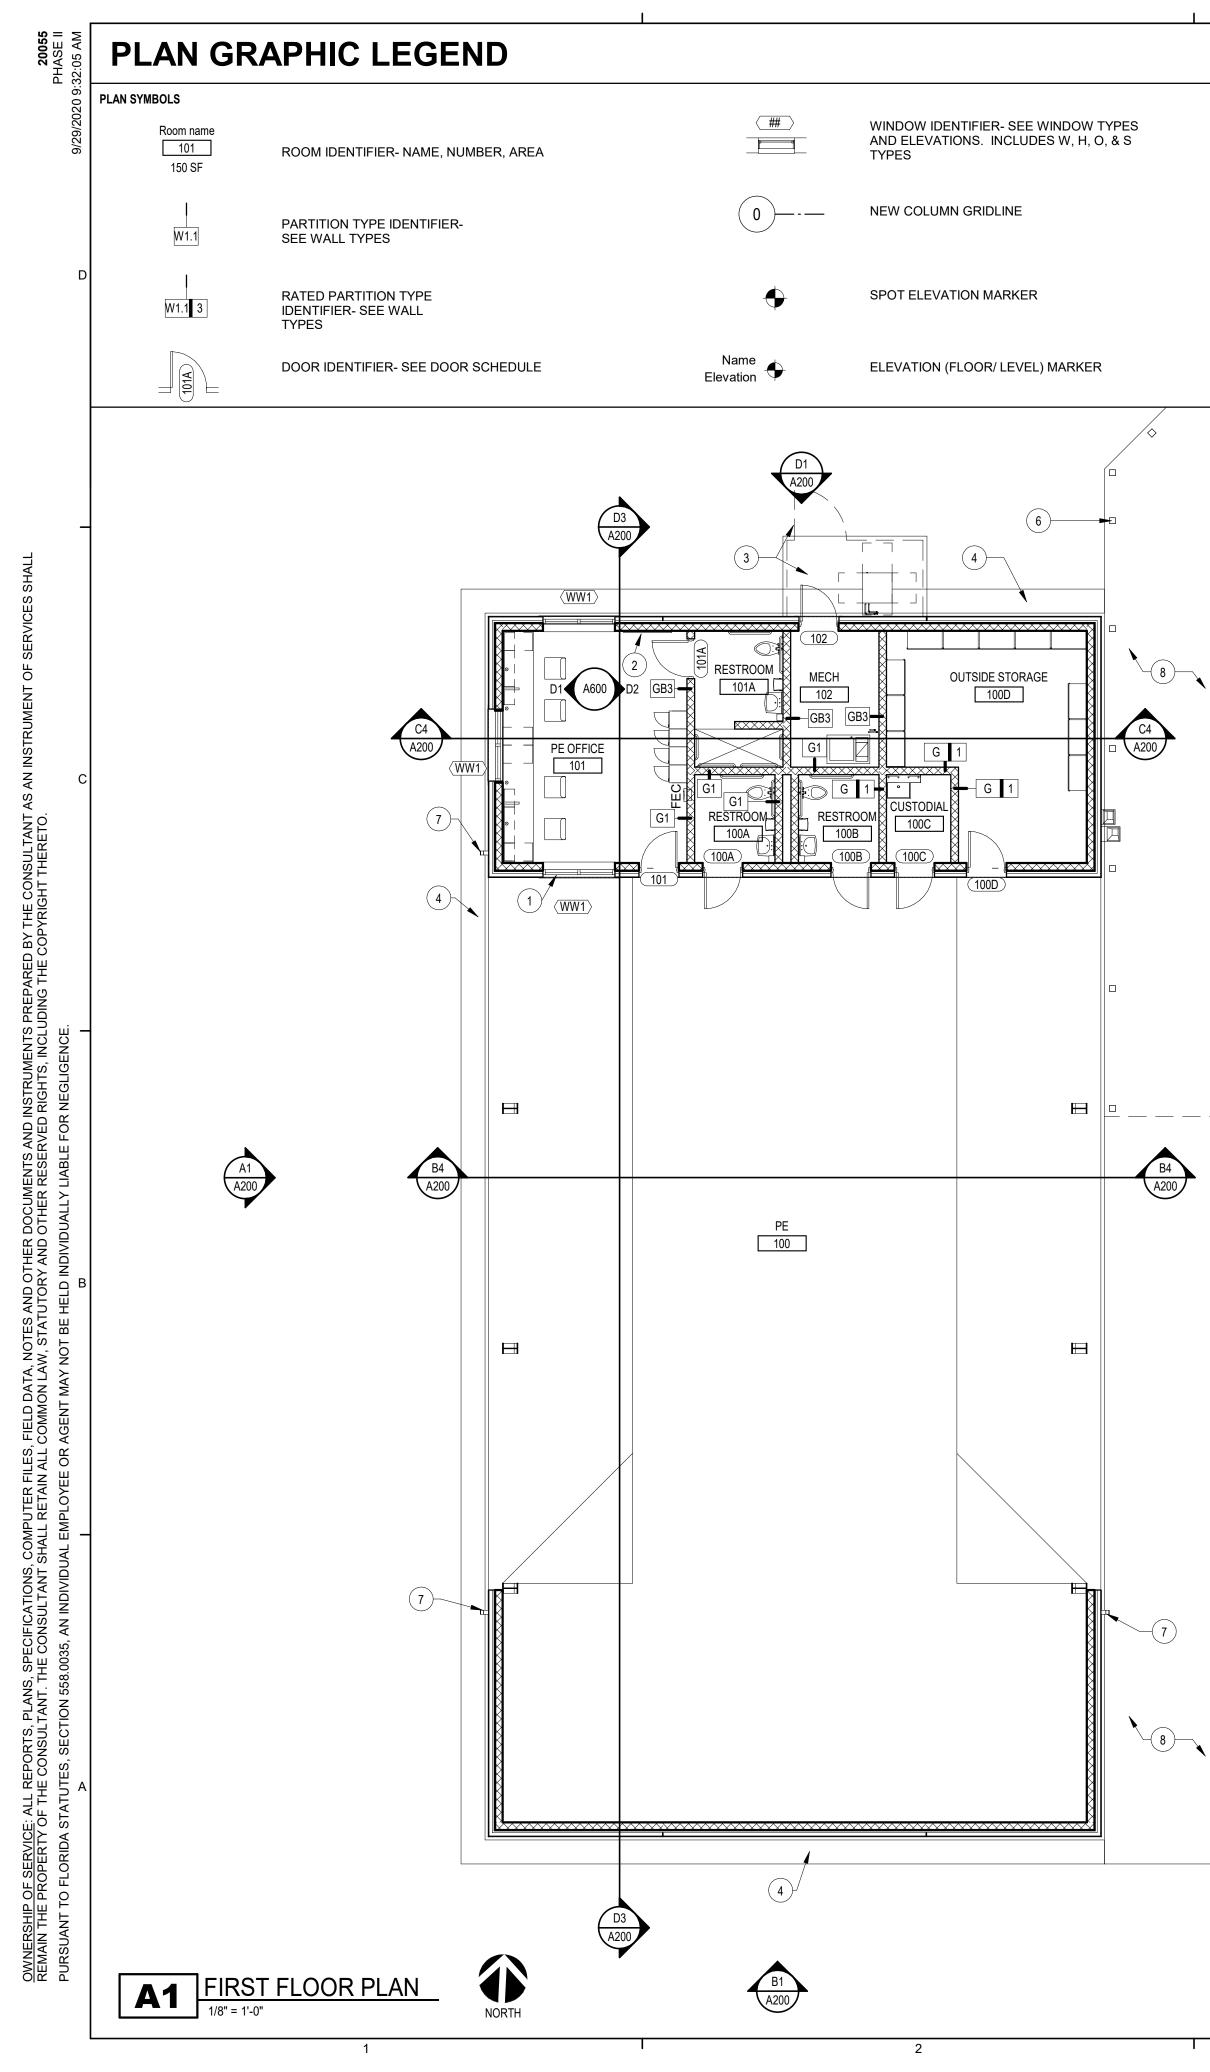


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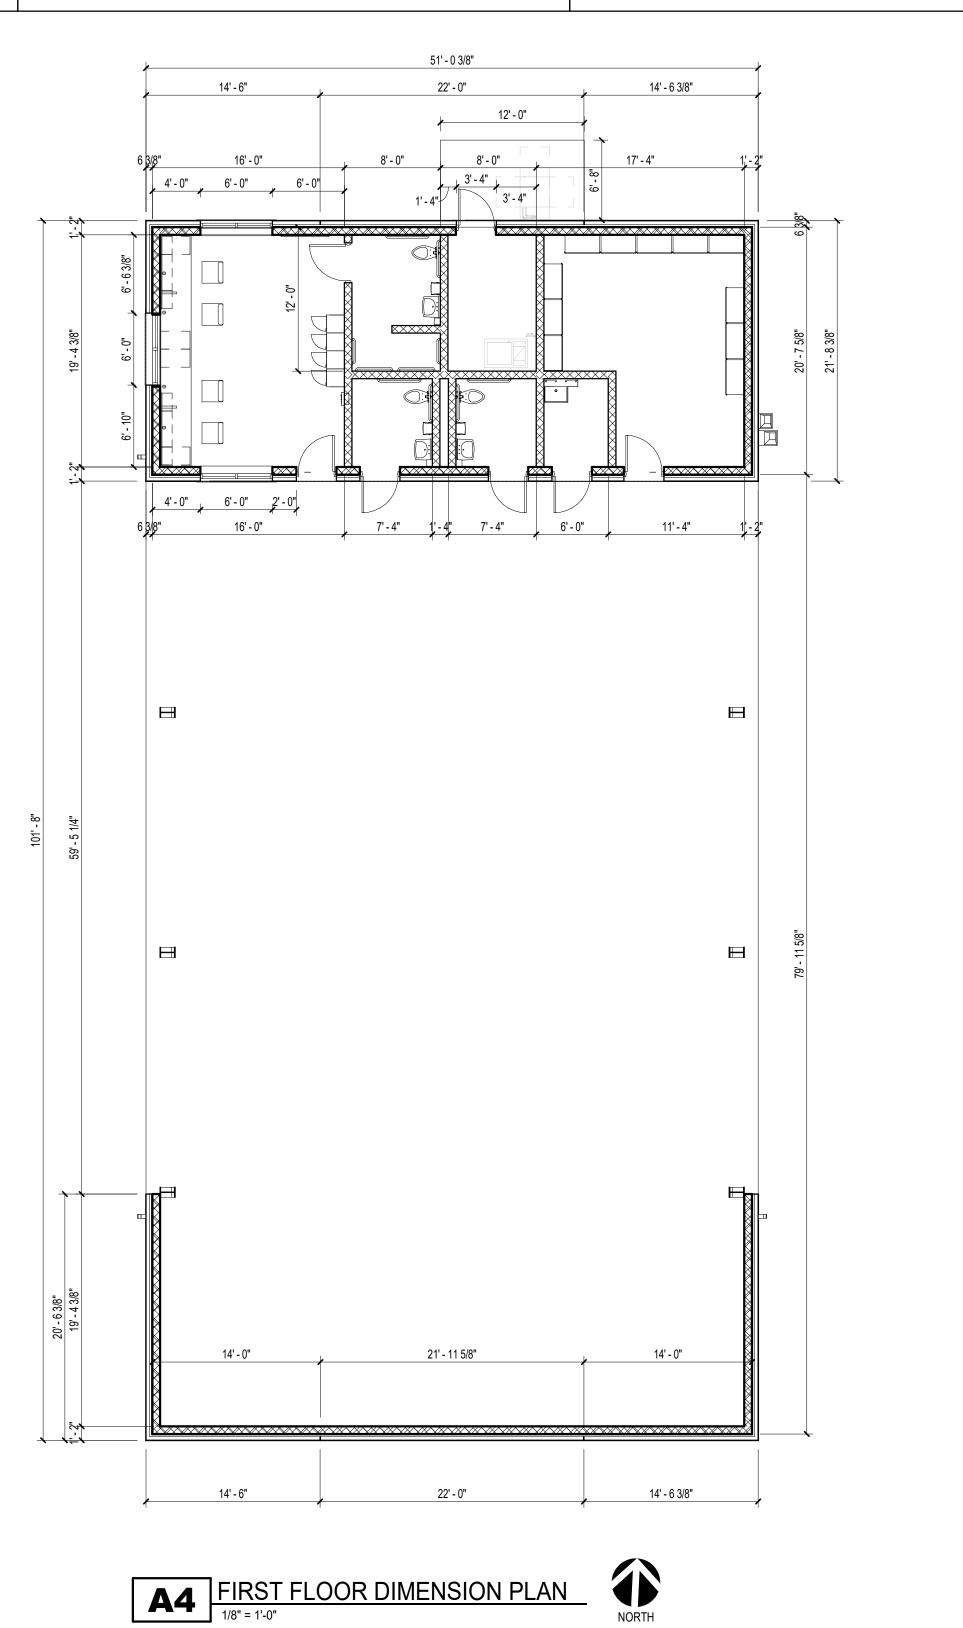


S101



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	PLAN GENERAL NOTES	PL/
FE FIRE EXTINGUISHER (BRACKET MOUNTED) REFER TO SPECIFICATIONS FEC FIRE EXTINGUISHER (CABINET) REFER TO SPECIFICATIONS	 CONTRACTOR SHALL COORDINATE WORK WITH STRUCTURAL, MECHANICAL, ELECTRICAL AND PLUMBING DRAWINGS. ALL DIMENSIONS ARE FROM FACE OF STUD OR CMU UNLESS NOTED OTHERWISE. REFER TO LIFE SAFETY PLAN AND FOR FIRE RATED AND SMOKE RATED WALL LOCATIONS. REFER TO SHEET A001 FOR WALL TYPE ASSEMBLIES. REFER TO SHEET A001 FOR WALL TYPE ASSEMBLIES. REFER TO SHEET A600 FOR DOOR AND WINDOW SCHEDULES. REFER TO SHEET A600 FOR DOOR AND WINDOW SCHEDULES. REFER TO ENLARGED PLANS FOR ADDITIONAL INTERIOR ELEVATION TAGS AND ADDITIONAL DIMENSIONS. PROVIDE SPECIAL CMU AND BRICK SHAPES AS REQUIRED BY DETAILS AND TO PROVIDE FINISHED/FACTORY MASONRY EDGES AT OPENINGS. CUT CMU AND BRICK MASONRY AS REQUIRED. REFER TO STRUCTURAL DRAWINGS FOR BRACING LOCATIONS, INFILL/SLOPE FRAMING AND TYPICAL CONSTRUCTION AS REQUIRED. SEE SITE PLAN FOR SIDEWALKS, FENCING, ETC. REFERNCE DETAIL D5 ON SHEET A400 FOR TYPICAL INTERIOR DOOR INSTALL FOR DOORS NEAR SIDE WALLS. 	$ \begin{array}{cccccccccccccccccccccccccccccccccccc$

C1 A200



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AN SHEET NOTES

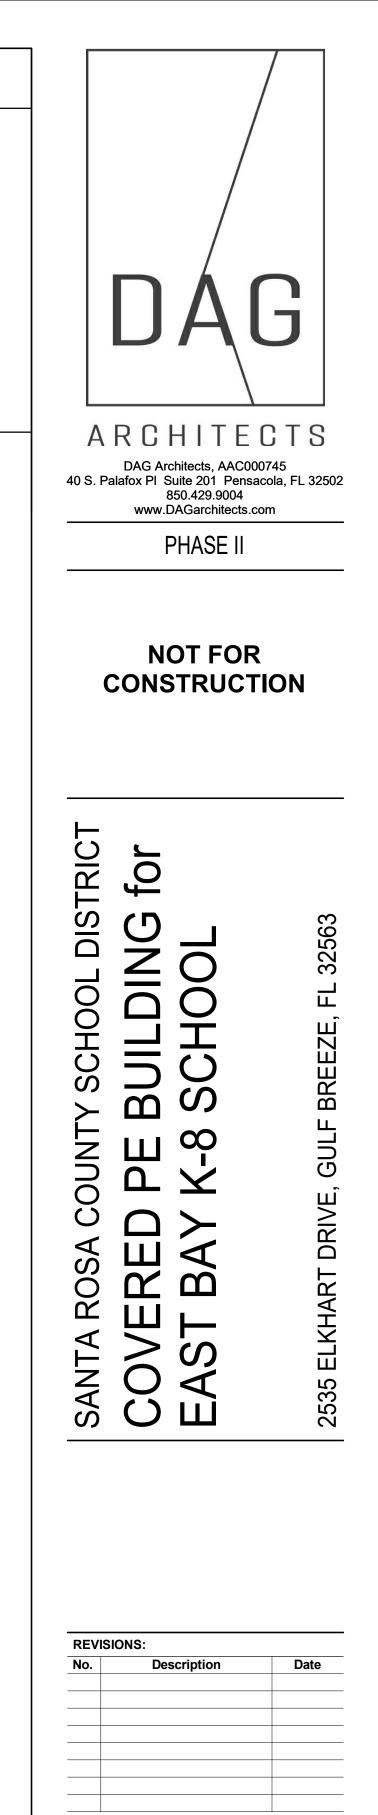
WIRE MESH WINDOW PROTECTION , SEE SPECIFICATIONS. 4'-0" W x 4'-0" H MARKER BOARD.

4" THICK CONCRETE PAD W/ 8"X8" TURN DOWN EDGE W/ 2-#5 CONT. 6' HIGH CHAIN LINK FENCE, 3' WIDE SING GATES WHERE SHOWN. SIDEWALK STEPS DOWN 2" AT MECHANICAL ROOM. 24" WIDE X 4" THICK CONCRETE MOW STRIP, 8" TURN DOWN EDGE

SIDEWALK CONTROL JOINT, TYP.

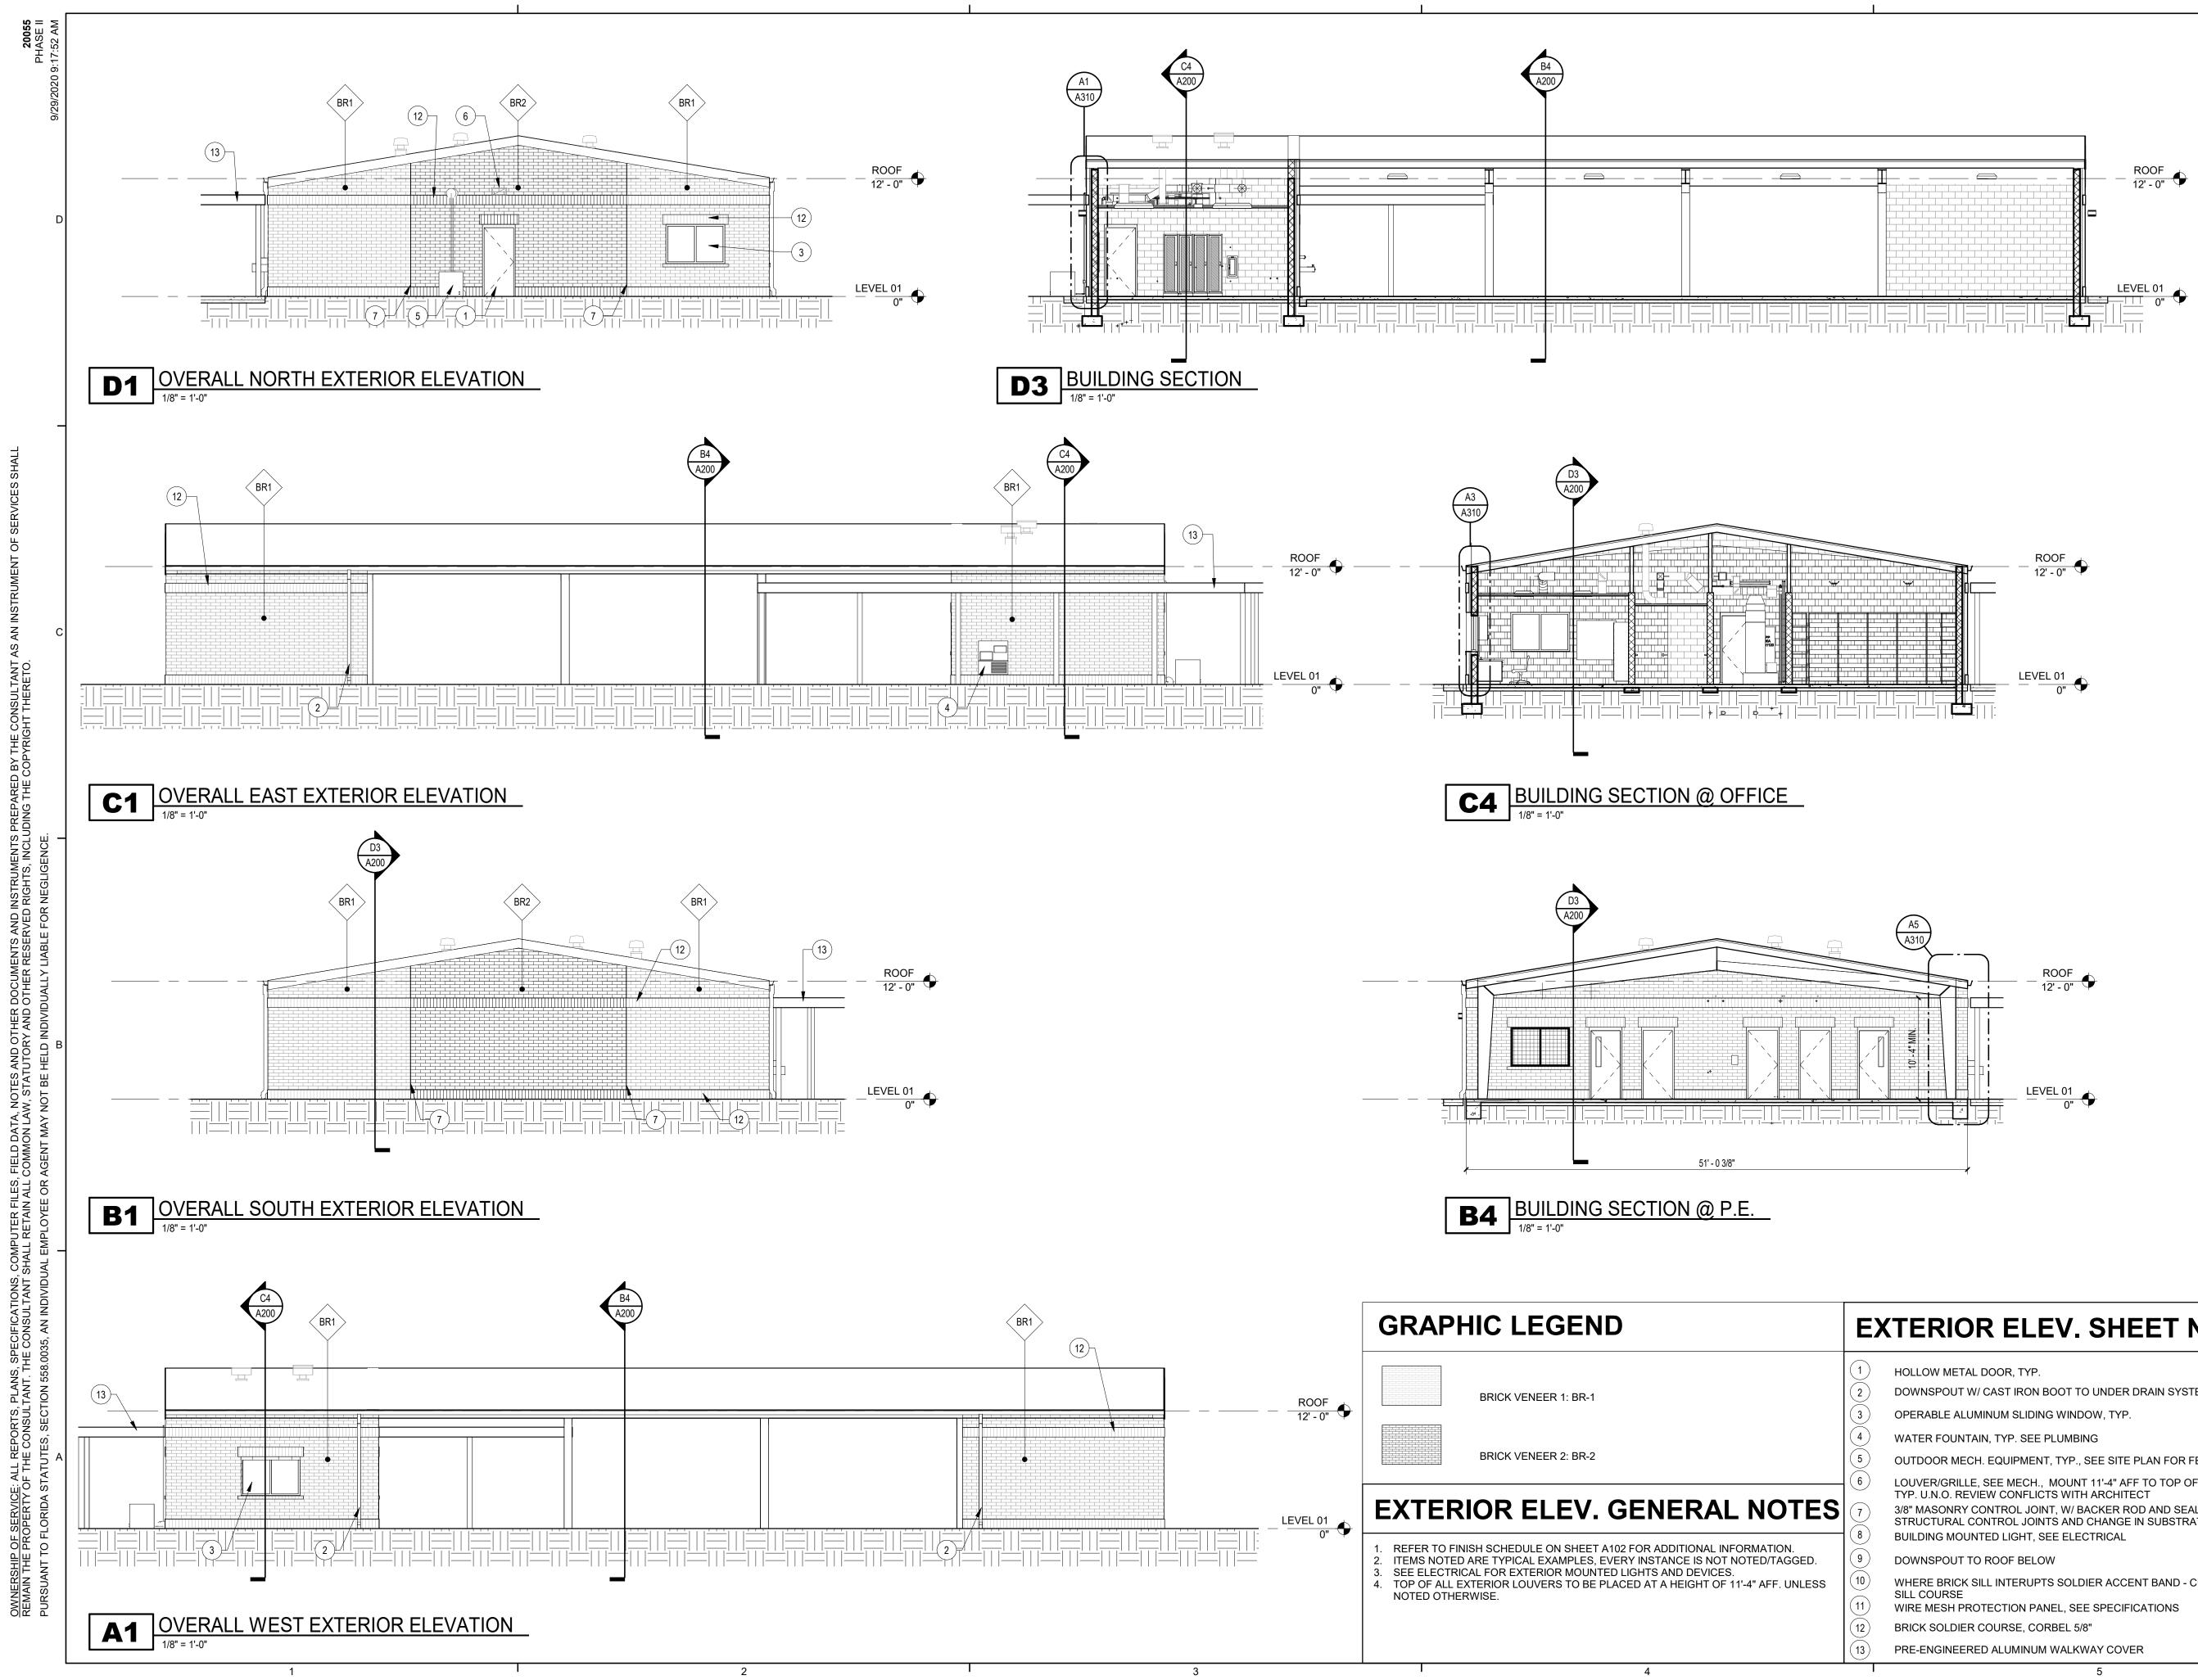
PRE-ENGINEERED ALUMINUM WALKWAY COVER, SEE DETAILS AND SPECS FOR MORE INFORMATION DOWNSPOUT WITH BOOT TO UNDERGROUND DRAIN

4" THICK CONCRETE SIDEWALK W/ MIN. 8"X8" TURN DOWN EDGE W/ 2-#5 CONT. PROVIDE MIN. 24" X 24" X 24" FOOTINGS, AT WALKWAY COVER COLUMNS, CONFIRM FINAL SIZE WITH MANUFACTURER/ENGINEER



FLOOR PLAN & DIMENSION PLAN

Project Numbe	er 20055
Dated	September 29, 2020
Drawn By	Author
Approved By	Approver
PM	Designer
A	101



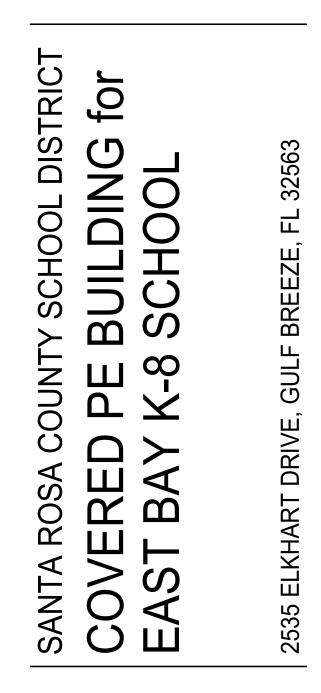
EXTERIOR ELEV. SHEET NOTES

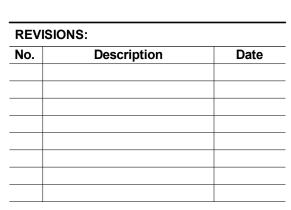
- DOWNSPOUT W/ CAST IRON BOOT TO UNDER DRAIN SYSTEM, TYP.

- OUTDOOR MECH. EQUIPMENT, TYP., SEE SITE PLAN FOR FENCING
- LOUVER/GRILLE, SEE MECH., MOUNT 11'-4" AFF TO TOP OF LOUVER OR GRILLE,
- 3/8" MASONRY CONTROL JOINT, W/ BACKER ROD AND SEALANT, TYP. ALIGN WITH STRUCTURAL CONTROL JOINTS AND CHANGE IN SUBSTRATE WHERE APPLICABLE
- WHERE BRICK SILL INTERUPTS SOLDIER ACCENT BAND CUT SOLDIER BELOW



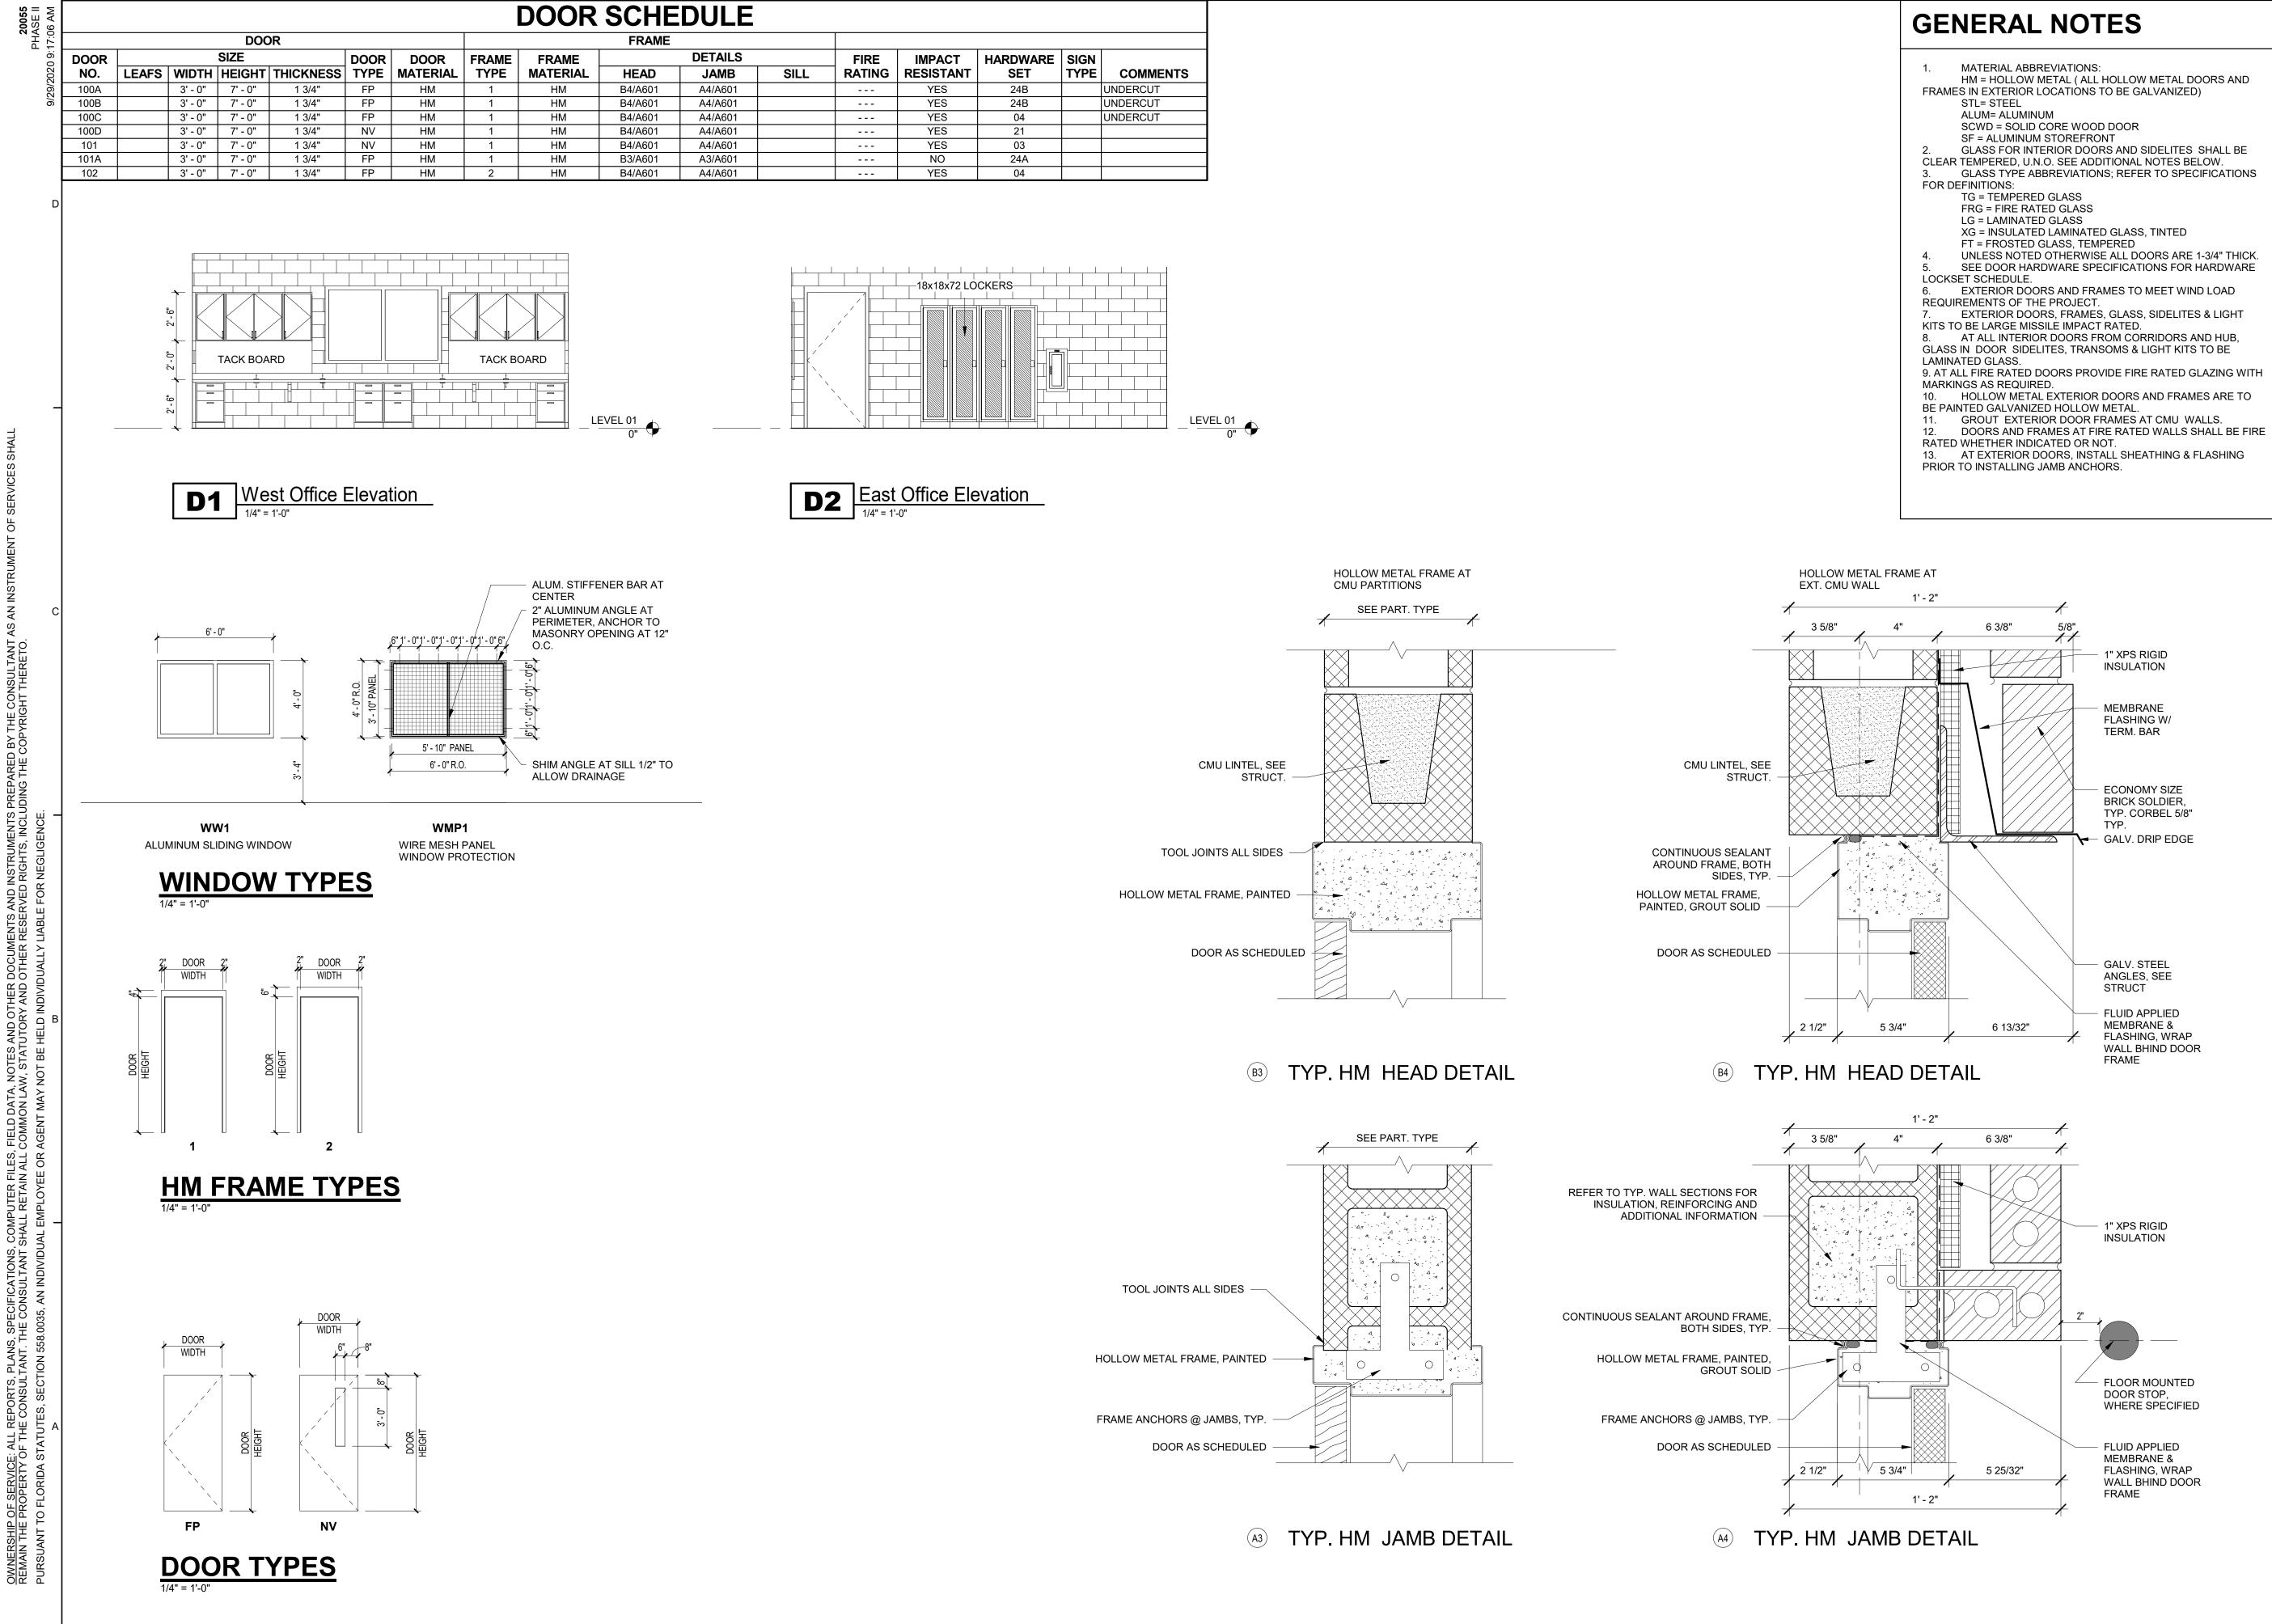
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BUILDING ELEVATIONS & SECTIONS

Project Num	ber 20055
Dated	September 29, 2020
Drawn By	Author
Approved By	Approver
PM	Designer
	4200



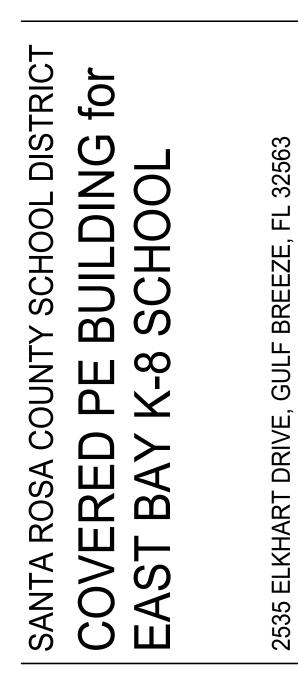
IMPACT ESISTANT	HARDWARE SET	SIGN TYPE	COMMENTS
YES	24B		UNDERCUT
YES	24B		UNDERCUT
YES	04		UNDERCUT
YES	21		
YES	03		
NO	24A		
YES	04		

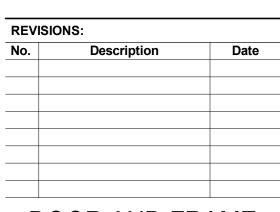
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NOT FOR CONSTRUCTION





DOOR AND FRAME SCHEDULE

Project Numb	er 20055
Dated	September 29, 2020
Drawn By	Author
Approved By	Approver
PM	Designer
ļ	4600

				FIXTURE		CONNEC	CTIONS			
P-1 P-2 P-3 P-4			WASTE	VENT	CW					
MARK	FIXTURE NAME	TYPE	DESIGN	DESCRIPTION	IN	IN	IN			
	FIXTURE NAME TYPE BASIS OF DESCRIPTION DESCRIPTION WASTE VENT C/W WATER CLOSET FLOOR MOUNT AMERICAN STANDARD ELONGATED RIM, VITREOUS CHINA, FLUSH TANK, TOP SPUD, 157 RIM HEIGHT, WHITE OPEN FRONT TOLLET SEAT COVER MUTH STAINLESS STEEL CLEAR MOUND STANDARD 11/2 1									
P-1	WATER GLOSET	FLOOR MOUNT	_		3	1 1/2				
		FIXTURE CONNECTIONS TURE NAME TYPE BASIS OF DESIGN WASTE VENT WENT WASTE VENT WENT WENT								
P-2	LAVATORY	WALL MOUNT	ZURN		2	1 1/4	1/2			
			-	REFER TO ARCHITECTURE FOR SHOWER WALLS AND FLOOR.				_		
P-3	Image: Second									
P-4	MOP SINK	_	FIAT		3	1 1/2	1/2	2		
	MOP SINK		ZURN	CHROME PLATED, ADJUSTABLE WALL BRACE, PAIL HOOK, FOUR ARM HANDLES, HOSE THREADED SPOUT.			.,			
P-5	DRINKING FOUNTAIN	-	HAWS	PUSH BUTTON, LEAD FREE, GALVANIZED STEEL FRAME WITH STAINLESS STEEL TOP, HEAVY DUTY BUBBLER. PROVIDE WITH CONCEALED WALL SUPPORT. PROVIDE WITH PNEUMATIC OPERATED FREEZE RESISTANT VALVE MOUNTED IN MFR.	1 1/2	1 1/4	1/2	-		
P-6	BOTTLE FILLER	-	HAWS	PUSH BUTTON, LEAD FREE. PROVIDE WITH CONCEALED WALL SUPPORT. PROVIDE BOTTLE FILLER THAT CAN BE MOUNTED OVER PROVIDED DRINKING FOUNTAIN. PROVIDE WITH PNEUMATIC OPERATED FREEZE RESISTANT VALVE MOUNTED IN MFR. CABINET. CABINET SHALL BE MOUNTED SUCH THAT FACE OF CABINET IS FLUSH WITH INTERIOR FACE	1 1/2	1 1/4	1/2			
FD	FLOOR DRAIN	-	ZURN		WASTE VENT CW IN IN IN IN COVER 3 1 1/2 1 N GUARD 3 1 1/2 1 IOLES. 2 1 1/4 1/2 NDAL 2 1 1/4 1/2 BODY AND - - 1/2 BODY AND - - 1/2 SISTANT, OVIDE D IN MFR. 1 1/2 1 1/2 1/2 ANT, EXIVE IOR FACE 1 1/2 1 1/4 1/2 RAINER, ALVE IOR FACE 3 1 1/2 1 1/2 RAINER, ALVE IOR FACE 3 1 1/2 1/2 RAINER, ALVE IOR FACE 3 1 1/2 1/2 RAINER, IOR FACE 3 1 1/2 1/2 RAINER, IED BOX - - 3/4	-				
SD	SHOWER DRAIN	-	ZURN		2	1 1/2	1/2			
HB	HOSE BIBB	-	WOODFORD	ANTI SIPHON, VACUUM BREAKER, CHROME FINISH.	ANK, NON-HOLD OPEN NO LEAK HANDLE, ADJUSTABLE TAIL PIECE, INTERNAL SIPHON GUARD NG, CHROME PLATED.311/21.FRONT OVERFLOW, SELF DRAINING DECK WITH BACK SPLASH, 4" CENTER FACUET HOLES. DARM CARRIER.211/41/21/2FAUCET WITH INTEGRAL SHANKS, QUARTER TURN DISC CARTRIDGES, 4" SPOUT, VANDAL METAL LEVER HANDLES. PROVIDE WITH ADA PROTECTORS FOR STOPS AND TRAP.211/41/21/2FOR SHOWER WALLS AND FLOOR. VOLE METEL LEVER HANDLE PRESSURE BALANCE MIXING VALVE WITH CAST BRASS BODY AND CTION CAPABILITY, CHROME FINISH1/21/21/2MOLDED HIGH DENSITY, S.S. STRAINER, S.S. BUMPER GUARD ON ALL CURBS AND D1/21/21/2IBLE WALL BRACE, PAIL HOOK, FOUR ARM HANDLES, HOSE THREADED SPOUT.3111/21/21/2ER FREE, OUTDOOR DRINKING FOUNTAIN, SELF CONTAINED, WALL HUNG, VANDAL RESISTANT, GALVANIZED STEEL FRAME WITH STAINLESS STEEL TOP, HEAVY DUTY BUBBLER, PROVIDE POOT, PROVIDE WITH PRUMATIC OPERATED FREEZE RESISTANT VALVE MOUNTED IN MFR.111/211/41/2-ER FREE, OUTDOOR BOTTLE FILLER, SELF CONTAINED, WALL HUNG, VANDAL RESISTANT, PROVIDE WITH HONDOWDE WITH PREUMATIC OPERATED FREEZE RESISTANT VALVE E MOUNTED SUCH THAT FACE OF CABINET IS FLUSH WITH INTERIOR FACE OF WALL.111/211/2-COUTLET, INVERTIBLE MEMBRANE CLAMP, ADJUSTABLE COLLAR, NICKEL BRONZE STRAINER, L,3111/21/2-OUTLET, INVERTIBLE MEMBRANE CLAMP, ADJUSTABLE COLLAR, NICKEL BRONZE STRAINER, L,211/21/2-OUTLET, INVERTIBLE MEMBRANE CLAMP, ADJUSTABLE COLLAR,					
WH	WALL HYDRANT	-	ZURN PROVIDE WITH CONCEALED ARM CARRIER. 2 11/4 ZURN 0.5 GPM, CHROME PLATED, FAUCET WITH INTEGRAL SHANKS, QUARTER TURN DISC CARTRIDGES, 4" SPOUT, VANDAL, RESISTANT, COLOR CODED METAL LEVER HANDLES. PROVIDE WITH ADA PROTECTORS FOR STOPS AND TRAP. 2 1.1/4 Marcican 1.5 GPM, CHROME PLATED, FAUCET WITH INTEGRAL SHANKS, QUARTER TURN DISC CARTRIDGES, 4" SPOUT, VANDAL, RESISTANT, COLOR CODED METAL LEVER HANDLES. PROVIDE WITH ADA PROTECTORS FOR STOPS AND TRAP. - - MARCICAN 1.5 GPM SHOWER HEAD, SINGLE METEL LEVER HANDLE PRESSURE BALANCE MIXING VALVE WITH CAST BRASS BODY AND STANDARD BUILT IN REVERSE CONNECTION CAPABILITY, CHROME FINISH. -	3/4						
MV	MIXING VALVE	-	LEONARD	AND DOOR, LOOSE KEY OPERATED, CHROME FINISH.						

1. WATER SUPPLY TAPPING TO EACH FIXTURE SHALL BE FULL SIZE.

2. PROVIDE WATER HAMMER ARRESTORS ON HOT & COLD WATER SUPPLY BRANCHES SERVING SINGULAR, MULTIPLE OR GROUPS OF PLUMBING FIXTURES. ADHERENCE TO THE PLUMBING AND DRAINAGE INSTITUTE STANDARD P.D.I.-WH201 (PER SPECIFICATIONS) SHALL BE EMPLOYED IN DETERMINING PROPER SIZE SELECTION, PLACEMENT, LOCATION AND INSTALLATION OF ARRESTORS.

3. MOUNT PLUMBING FIXTURES LABELED "ADA" IN ACCORDANCE WITH ADA REQUIREMENTS. COORDINATE WITH ARCHITECTURAL DRAWINGS.

4. SEE ARCHITECTURAL FOR FIXTURE MOUNTING HEIGHTS.

5. PROVIDE FIXTURES WITH ALL APPURTENANCES AS NECESSARY FOR A COMPLETE INSTALLATION. (I.E. STOPS, FLEXIBLE CONNECTORS, ETC.)

6. VENT SIZE INDICATED IN SCHEDULE IS FOR INDIVIDUAL FIXTURE VENTING. SEE PLANS FOR VENT PIPE SIZES.

			DOMESTI	C WATER HEATI	NG SCHED	ULE			
			STORAGE CAPACITY	RECOVERY @ 80°F RISE	RELIEF VALVE SETTING	NO OF ELEMENTS	E	LECTRIC	AL INPUT
MARK	LOCATION	TYPE	GAL	GAL/H	PSIG	ELIEF ALVE TTING PSIG NO OF ELEMENTS ELECTRICAL TOTAL KW FLA	VOLT/PH/FREQ		
EWH-1	CUSTODIAL	TYPE GAL RECOVERY @ 80°F VALVE NO OF ELEMENTS ELECTRICAL INPUT	208/3/60						
NOTES:		-							

1. EWH SHALL MEET THE STANDBY LOSS REQUIREMENTS OF THE U.S. DEPARTMENT OF ENERGY AND CURRENT EDITION OF ASHRAE/IESNA 90.1.

2. VESSEL SHALL BE CONSTRUCTED TO SECTION IV OF THE ASME CODE FOR 150 PSIG WORKING PRESSURE AND GLASS-LINED WITH ANODIC PROTECTION ENTIRE VESSEL AND ELECTRICAL CONTROLS SHALL BE ENCASED IN A RECTANGULAR SHEET METAL ENCLOSURE WITH BAKED ENAMEL FINISH.

3 PROVIDE MAGNETIC CONTACTOR AND HEATING ELEMENT CIRCUIT PROTECTION. PROVIDE WITH A MASTER PILOT SWITCH AND ELECTRONIC LOW WATER CUTOFF.

2

3. PROVIDE WITH FACTORY INSTALLED TERMINAL BLOCK, FUSING TO PROTECT ALL ELEMENTS, THERMOSTATS, AND WIRING.

4. THERMOSTATIC CONTROL SHALL BE IN STAGES THROUGH MODULATING STEP CONTROL. UNIT SHALL BE PREWIRED TO SOLDERLESS TERMINAL LUGS, FACTORY TESTED, COMPLETE WITH A CSA CERTFIED AND ASME RATED T&P RELIEF VALVE.

5. UNIT SHALL BEAR THE UNDERWRITERS' LABORATORIES LABEL AND MEET ASME CERTIFICATION. PROVIDE UNIT WITH A MINIMUM OF 3 YEAR WARRANTY. 6. PROVIDE PRE-CHARGED EXPANSION TANK (FLEXIBLE DIAPHRAGM TYPE) ON CW INLET PER MFR RECOMMENDATIONS.

7. PROVIDE UNIT MOUNTED DISCONNECT SWITCH.

8. ROUTE T&P BLOW-OFF PIPING TO DRAIN PAN. ROUTE PIPING FROM DRAIN TO MOP SINK BELOW.

9. BASIS OF DESIGN IS A.O. SMITH DEL.

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	WATER HAMME	ER ARRI	ESTOR SCHEDULE	
P.D.I. SIZE	FIXTURE UNITS	SIZE	TYPE/MODEL NUMBER (WROUGHT COPPER SHELL)	NOTES
А	1-11	1/2"	75001-S	1,2
В	12-32	3/4"	75002-S	1,2
С	33-60	1"	75003-S	1,2

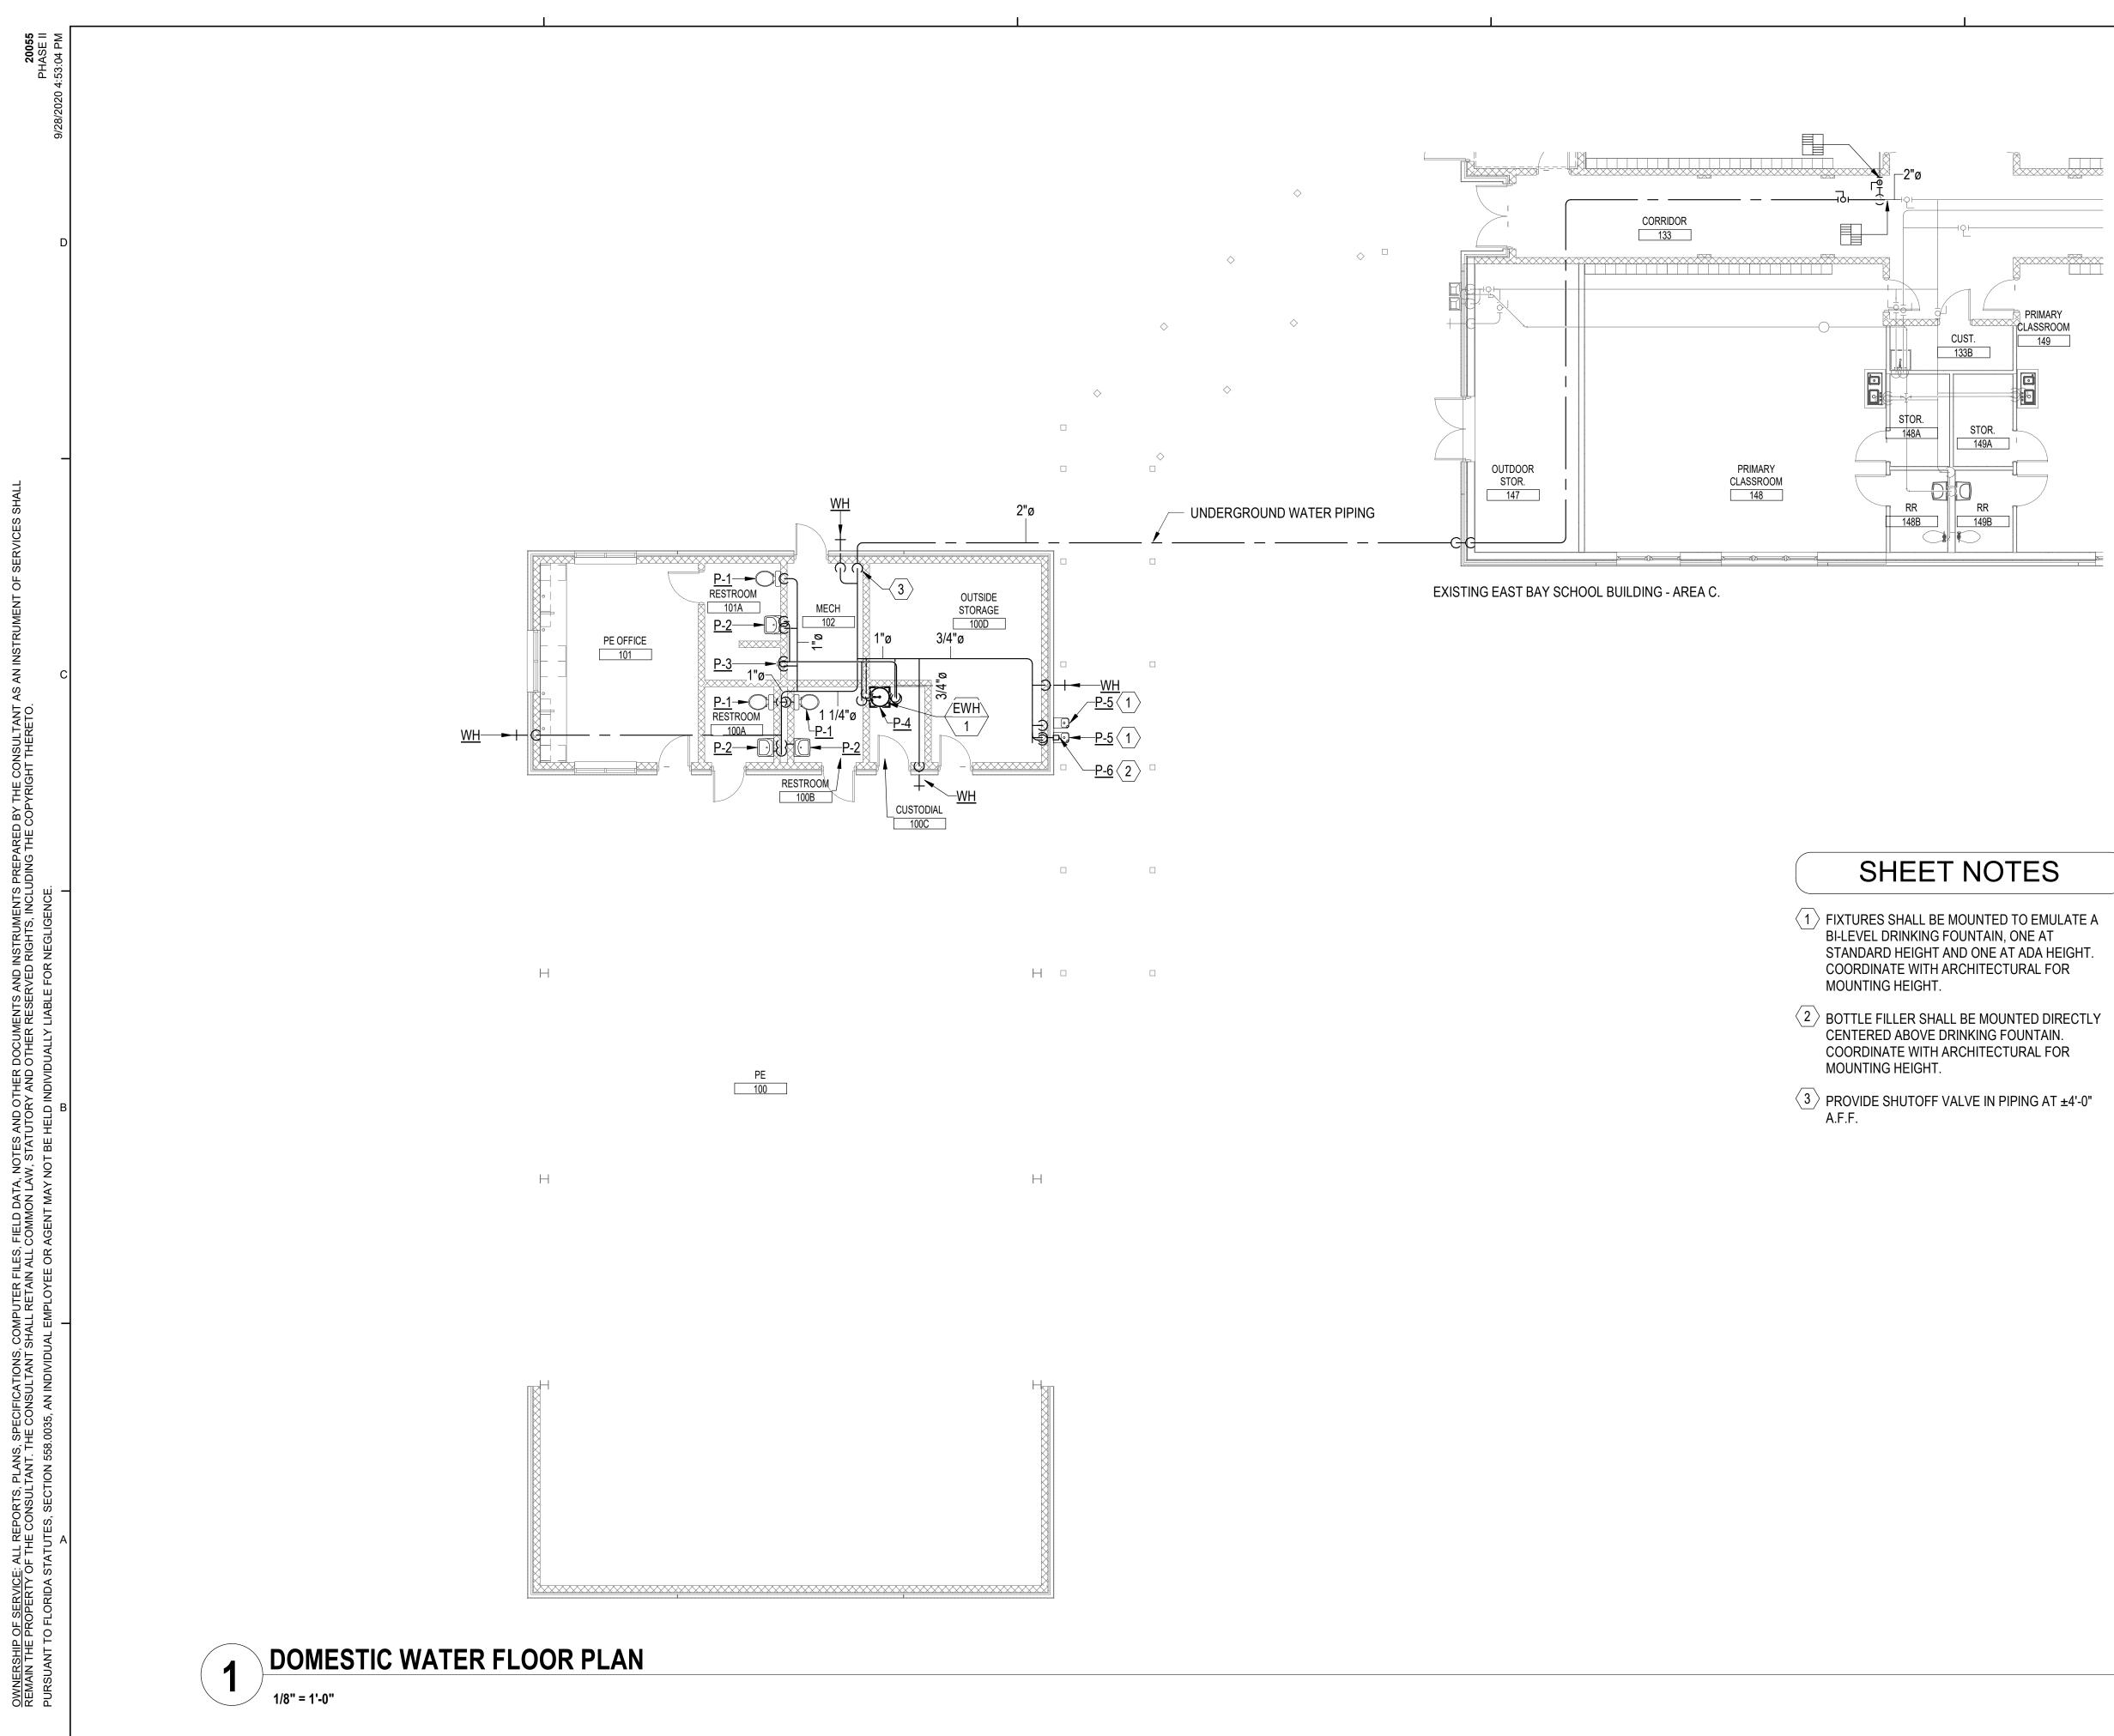
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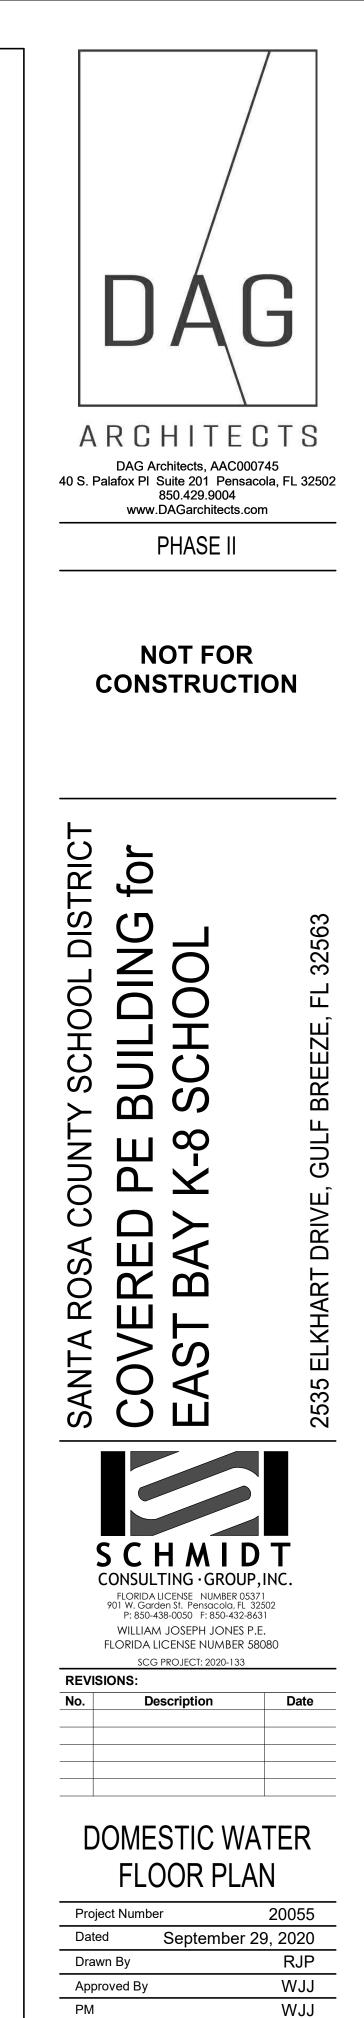
NOTES:

1. REPRESENTS PLUMBING AND DRAINAGE INSTITUTE "STANDARD P.D.I.-WH201".

2. REPRESENTS ARRESTOR TYPE AND ASSOCIATED MODEL NUMBER DERIVED FROM JOSAM CO. (SHOCK ABSORBERS, WROUGHT COPPER SHELL) AND IS USED AS A STANDARD FOR HELPING DETERMINE PROPER SELECTION FROM OTHER MANUFACTURERS EQUALLY COMPETENT IN THE FABRICATION OF AND USING THE SIZING METHOD ESTABLISHED IN ACCORDANCE WITH PLUMBING DRAINAGE INSTITUTE (P.D.I.).







								PORATOR				IG PERFORMANCE						AMRI	ENT TEMP.	NDENSING			-	ELECT	íŦ
				EAT	LAT	COIL COOLING PERI				EAT								SUMME			ESSOR	FAN			Γ
	ARIFLOW	OA	ESP	DB WB		TOTAL NB CAPACITY	SENSIBLE CAPACITY	LATENT CAPACITY	MAX. FACE VEL.		DB	TOTAL CAPACITY		BLOWER BLO	OWER	HEATER		DB	WB D				VOLT	PH	
MARK	(CFM)			DEG F) (DEG F)		EG F) (MBH)	(MBH)	(MBH)	(FPM)	SEER (MIN.) (DEG F)		(MBH)	COP (MIN.)	MOTOR MO	DTOR UNIT	KW (NOTE 5)	MARK		DEG F) (DE		RLA (EA.)	QTY. FLA (EA.)		F I I	
AH-1	925		, ,	74.5 61.9		50.0 31.2	23.3	7.9	500	14 66.9	85.0	18.7	3.3		2.60 3.0	5.3	HPU-1		81.0 30		14.1	1 0.64	208	1	
																									_
I <u>U NOTES:</u> 1 E	EXTERNAL STA	TIC PRESSURE	E (ESP) DOES	NOT INCLUDE PRF	SURE DROP THROU	GH COILS, DUCT HEATER	OR FILTERS.				Q	. PROVIDE 2" PLE	ATED FILTER		TER VELOCITY F		ЪW								
			χ γ			AND APPLICABLE CODES)S.			-	PROVIDE AHU V						NCE.							
		R MANUFACTU									11.	. SIZE REFRIGER	ANT LINES A	S PER MANUFA	CTURER'S RECO	MMDENDATION									
4. F	PROVIDE FACT	ORY MOUNTED	FIRE STATS ⁻	FO SHUT UNIT DO'	WN UPON DETECTIO	N OF EXCESSIVE HEAT IN	N THE				12.	. PROVIDE WITH	MULTI-STAGI	E SCROLL COM	PRESSOR AND L	ONG LINE KIT.									
S	3UPPLY SIDE D	ISCHARGE OF U	UNIT.								13.	. PROVIDE CORR	OSION PROT	ECTION COATI	NG ON COILS FO	R SEACOAST O	PERATION.								
		3PH-60HZ SCR E										. PROVIDE CONC													
											15.	. PROVIDE UNIT V AUTOMATIC DEI						IER DRYER, I	REFRIGERANTS	SIGHT GLASS					
		VERTICAL UPF		ILTER HOUSING.							16	BASIS OF DESIG			I, AND ADJUSTP		NVALVE.								
0. C				JIATION.							10.														
						FAN SCH	IEDULE										E	LECTRIC	UNIT HEA	TER SCHED	JLE		7		
						I	PERFORMANCE [EL	LECTRICAL DATA									ELECTRICAL	. DATA	_		
MARK		ATION	TYPE	DRIVE	CFM	E.S.P. (IN. W.C.)	MAX. RPM		IES N		OLTS	PHASE	Hz												
EF-1C EF-2C		D1A D0A	CEF	DD DD	80	0.20	900 950	0.4			20	1	60			MARK	HEAT kW	FAN CFM	UNIT AMF	VOLTS	PHASE	E Hz			
EF-2C EF-3C		00A 00B	CEF	DD	100	0.20	950	0.5			20	1	60 60		_	EUH - 1	1.5	150	12.50	120	1	60			
EF-4C		00C	CEF	DD	100	0.20	950	0.5			20	1	60		_	EUH - 2 EUH - 3	1.5 1.5	150 150	12.50 12.50	120	1	60	_		
															_	2011 0	1.0	100	12.00	120			-		
FAN NOTES:	-														l	UNIT HEATER N	OTES:		I		L L	!			
	 CEF - CEIL DD - DIRE(LING EXHAUST I	FAN																	MOUNTING BRAC	KET AND INST	ALL			
			EED CONTRO		W BALANCING. MOU	NT CONTROLLER WITHIN	FAN HOUSING.															-			
		FANS WITH AN															CONTROLS TR			SCONNECT, AND		-			
	5. PROVIDE	WITH GRAVITY	BACKDRAFT	DAMPER.													BASIS OF DESI								
	6. REFER TC	FIRE ALARM C	RAWINGS FO	R FIRE ALARM SH	UTDOWN RELAYS.										_	-									
																		DESIGN		DNS					
		DESIGN IS GRE		JY SENSOR AND E	LECTRIC UNIT HEAT	ER THERMOSTAT, SET TO	0 78 DEG F.											OUTSIDE		IN	SIDE				
	9. DASIS UF																DB (DEC	G. F) V	VB (DEG. F)	DB (DEG. F)	RH				
	N	/ENTILATO	JR SCHEE	JULE												SUMME			81	74	50%				
MARK	CFM	SP (IN W.G.	.) BASIS OF	DESIGN											1	WINTE NOTES:	R 30		-	70	-				
GR-1C	80	0.01	GREENHE	ECK FGR													1. INSIDE SUM	MMER DESIGN	I TEMPERATUR	E IS +0/-2 DEG. F.					
GR-2C	100	0.01	GREENHE	CK FGR													2. INSIDE SUM	MMER DESIGN	NRELATIVE HUN	IDITY IS +10%.					
GR-3C GR-4C	100 100	0.01	GREENHE GREENHE														3. INSIDE WIN	ITER DESIGN	TEMPERATURE	IS +2/-0 DEG. F.					
																	HI	EATING A	ND VENTI	ATING					
		ette, roof mo																OUTSIDE			SIDE				
)TES:		,		ND BACKDRAFT DA	AMPER.											_	DB (DEC		/B (DEG. F)	DB (DEG. F)	RH				
1.	PROVIDF WIT															SUMME			81	NOTE 1	-				
1. 2.			\T WIDTH x LE	NGTH = 8"x 8" AND	1														1						
1. 2. 3.	DIMENSIONAL			NGTH = 8"x 8" ANL)											WINTE NOTES:	R 30		-	55	-				

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DX SPLIT SYSTEM AIR HANDLING UNIT SCHEDULE

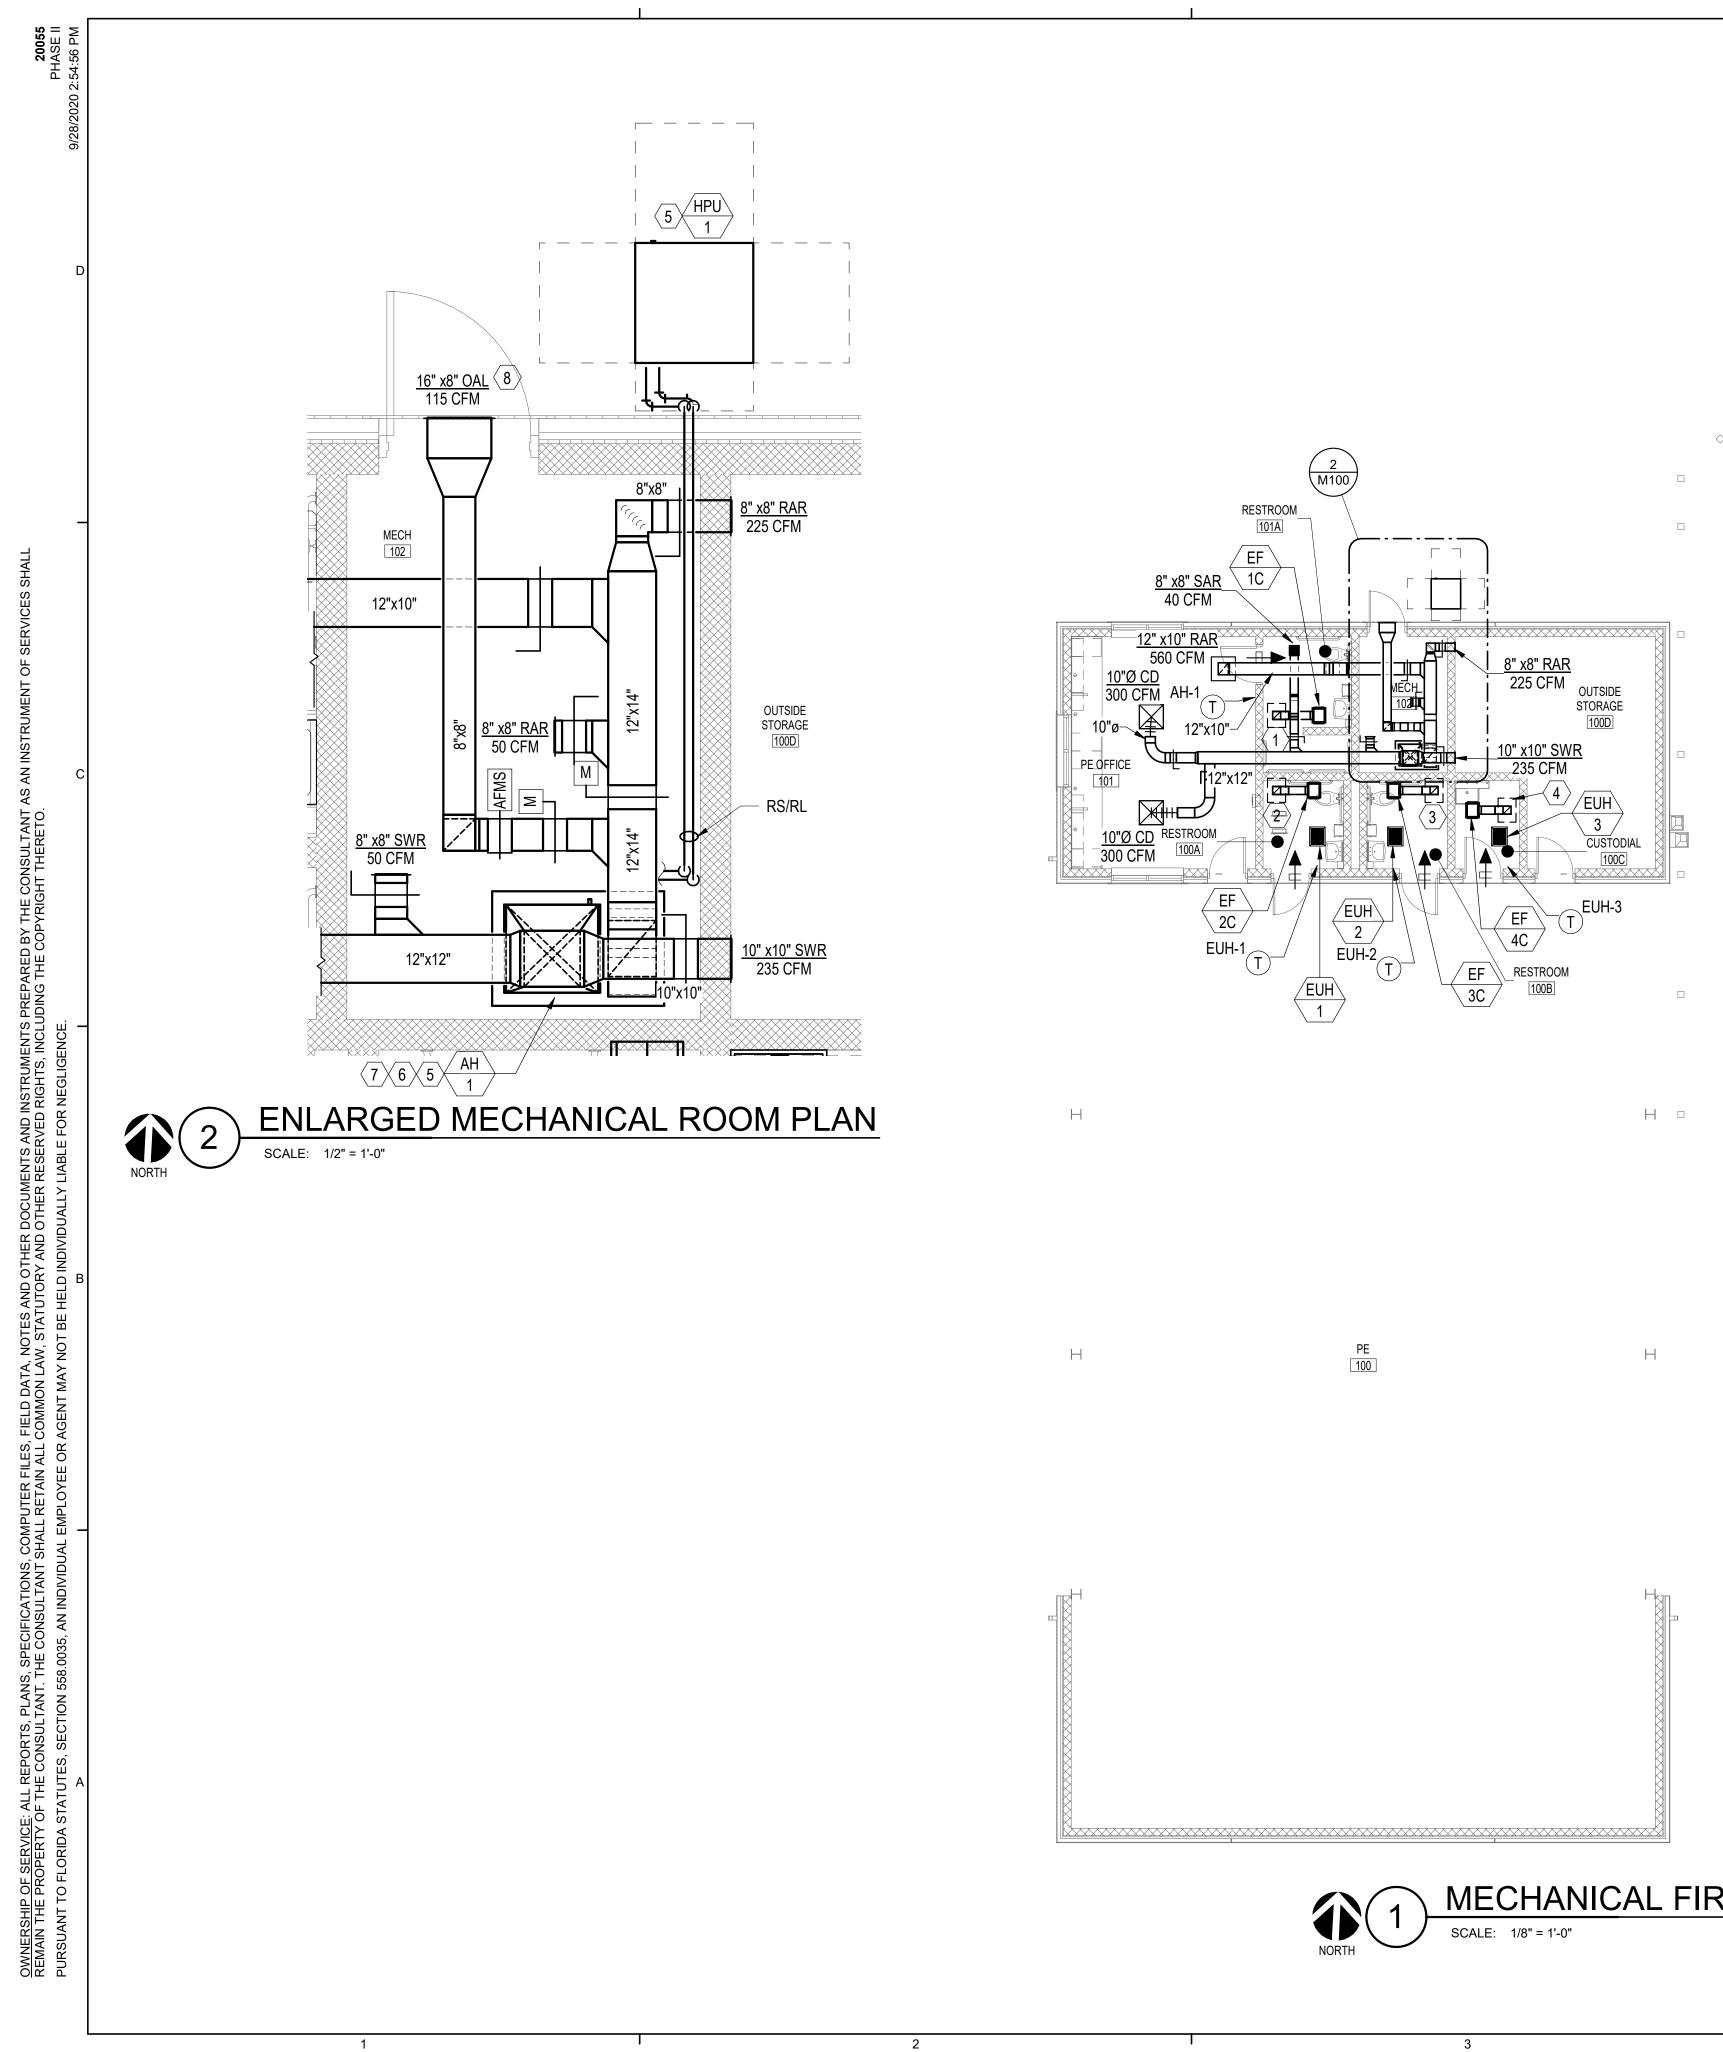
S	IDE
	RH
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M002





EXISTING EAST BAY K8 **BUILDING SHOWN** FOR COORDINATION ONLY

MECHANICAL FIRST FLOOR PLAN SCALE: 1/8" = 1'-0"

WING C

SHEET NOTES

- 1 ROUTE 8" x 8" EXHAUST DUCT UP TO GR-1C ON ROOF.
- $\langle 2 \rangle$ ROUTE 8" x 8" EXHAUST DUCT UP TO GR-2C ON ROOF.
- $\langle 3 \rangle$ ROUTE 8" x 8" EXHAUST DUCT UP TO GR-3C ON ROOF.
- $\langle 4 \rangle$ ROUTE 8" x 8" EXHAUST DUCT UP TO GR-4C ON ROOF.
- $\langle 5 \rangle$ MOUNT UNIT ON 6" CONCRETE PAD.
- 6 ROUTE CONDENSATE TO FLOOR DRAIN IN MECHANICAL ROOM.
- (7) ROUTE REFRIGERANT PIPING TO ASSOCIATED CONDENSING UNT.
- $\langle 8 \rangle$ MOUNT BOTTOM OF LOUVER AT ±10'-8" A.F.F.

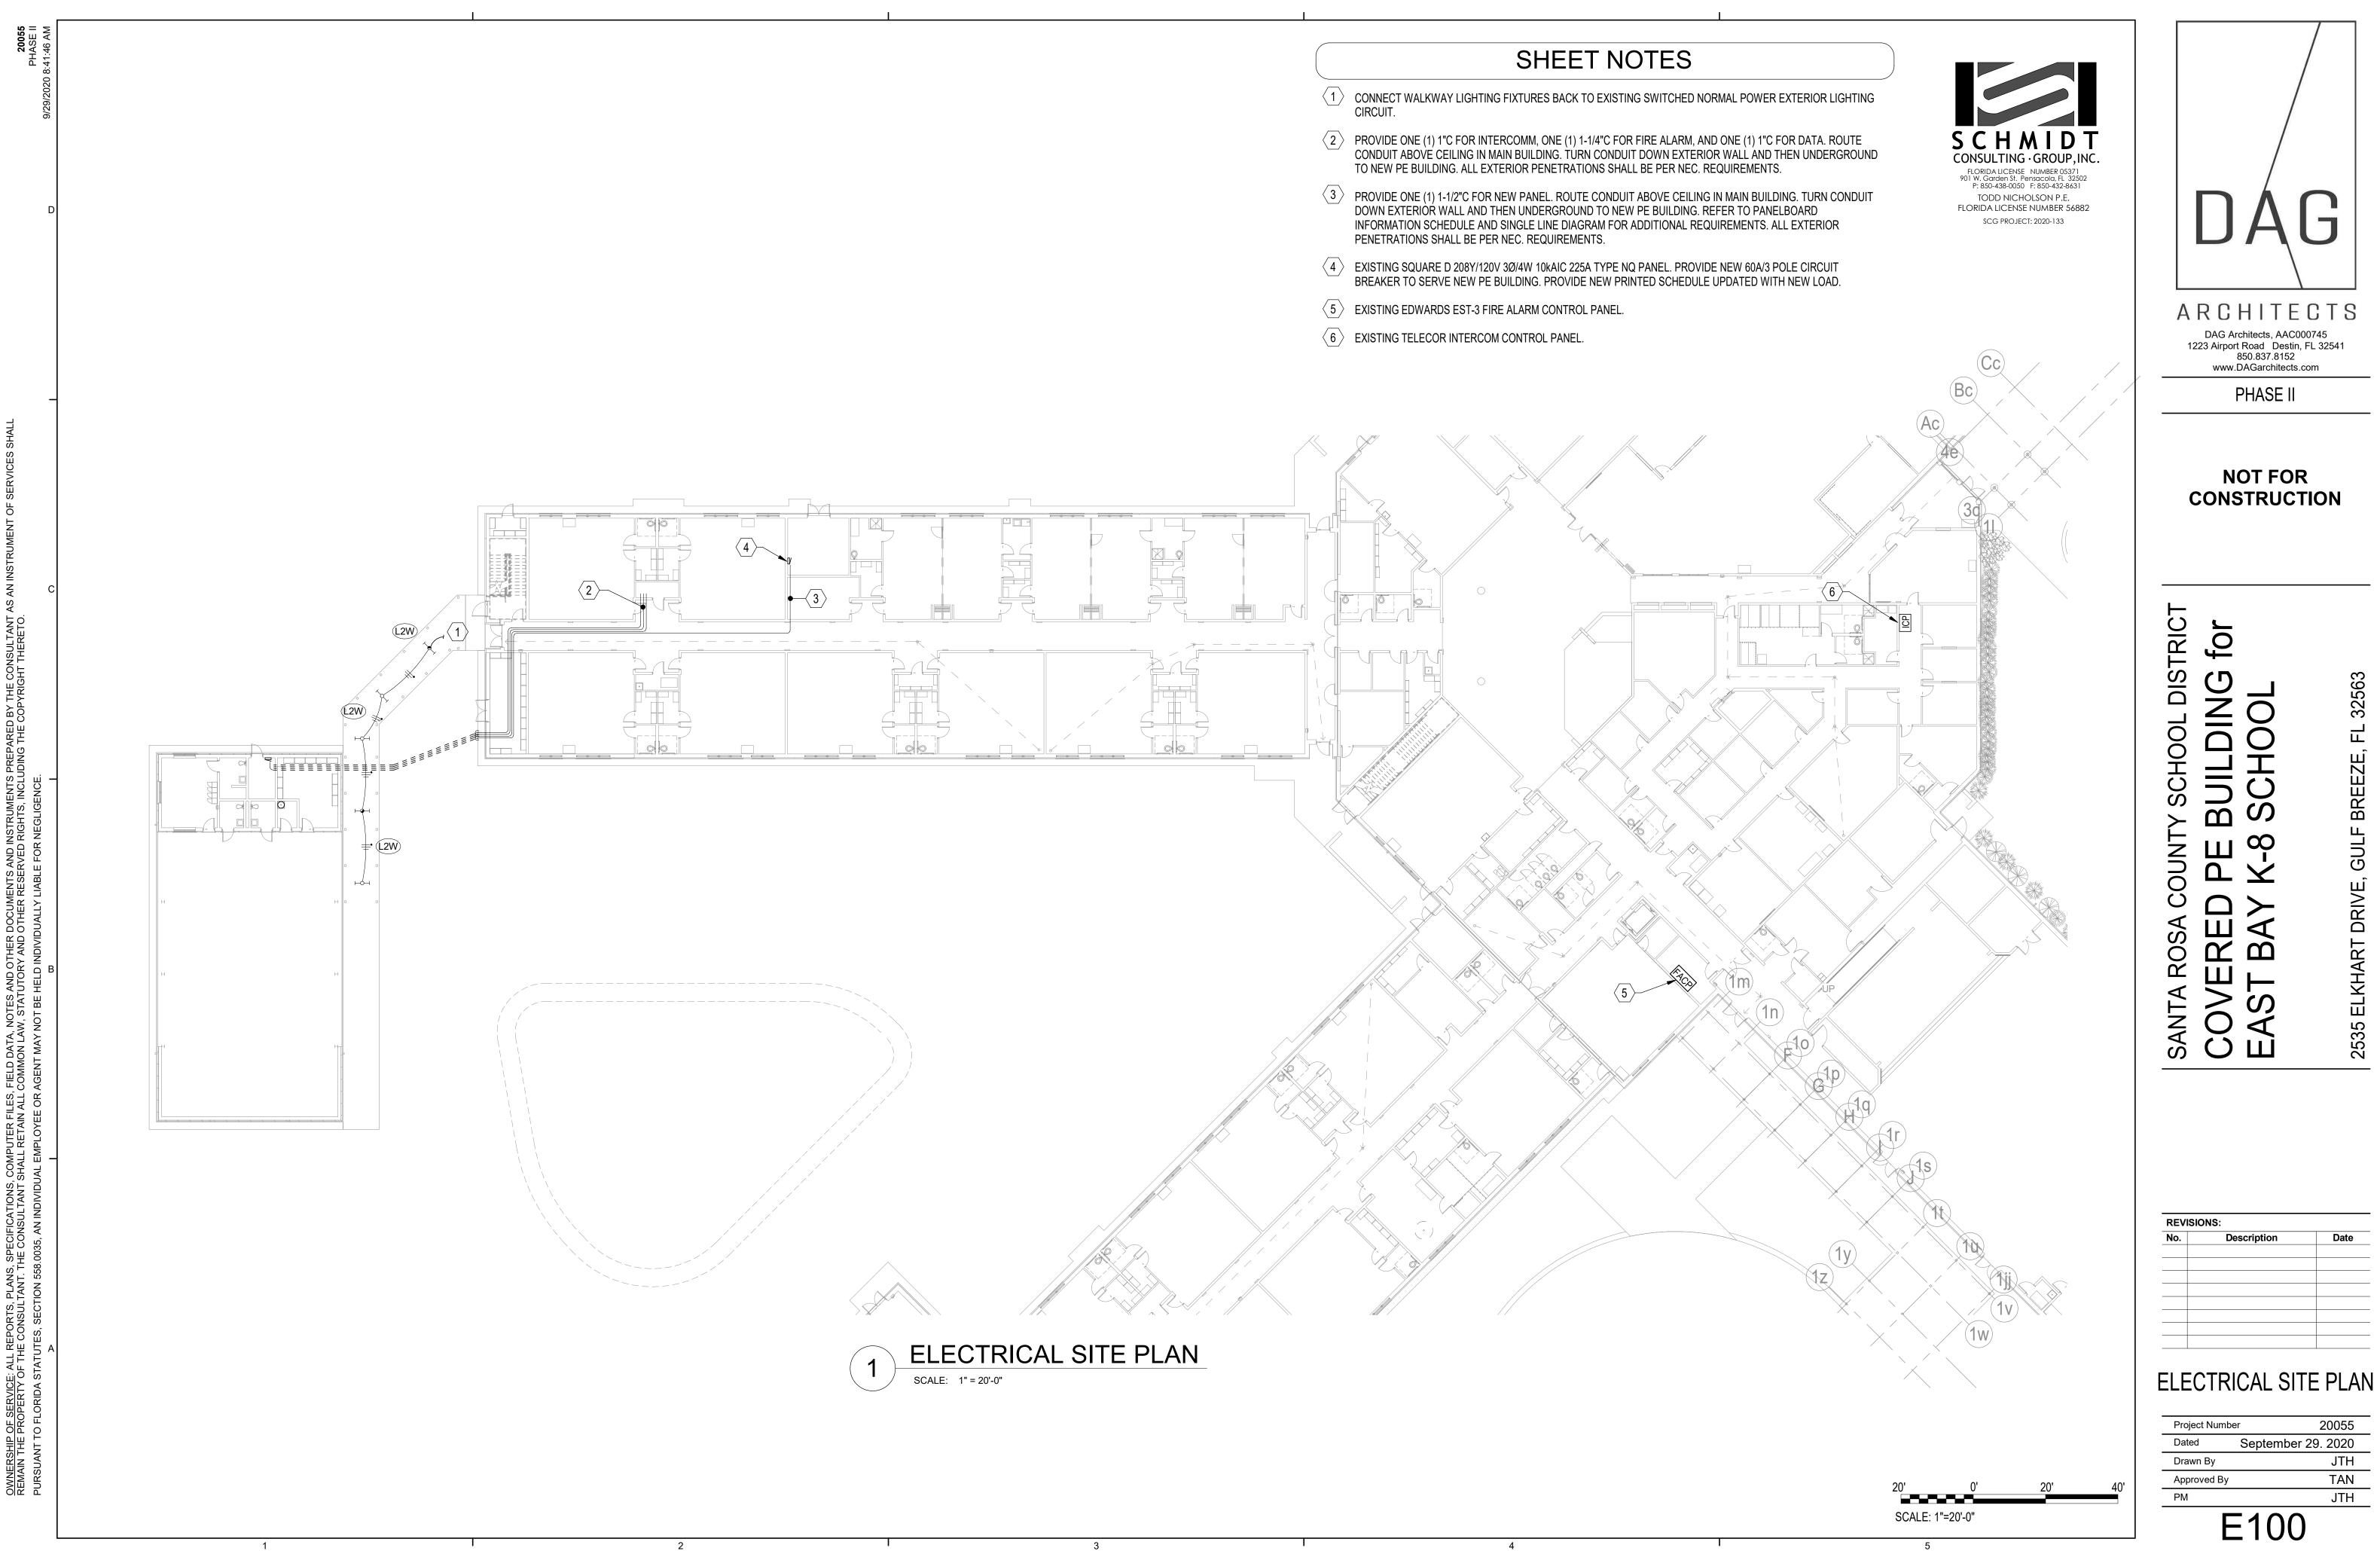
2'	0'	2'	4'
SCALE: 1	/2"=1'-0"		
8'	0'	8'	16'
SCALE: 1	/8"=1'-0"		
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SANTA ROSA COUNTY SCHOOL DISTRICT	COVERED PE BUILDING for	EAST BAY K-8 SCHOOL	2535 ELKHART DRIVE, GULF BREEZE, FL 32563	
SCHARLOS FLORIDA LICENSE NUMBER 05371 901 W. Garden St. Pensacola, FL 32502 P: 850-438-0050 F: 850-432-8631 WILLIAM JOSEPH JONES P.E. FLORIDA LICENSE NUMBER 58080				
REVIS No.	IONS:	PROJECT: 2020-133	Date	
MECHANICAL FLOOR PLANS				
Proje	ect Numbe	r	20055	
Date	d	September		
Draw	ın By		CAP	
Appr	oved By		WJJ	
PM			CAP	

M100



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Date

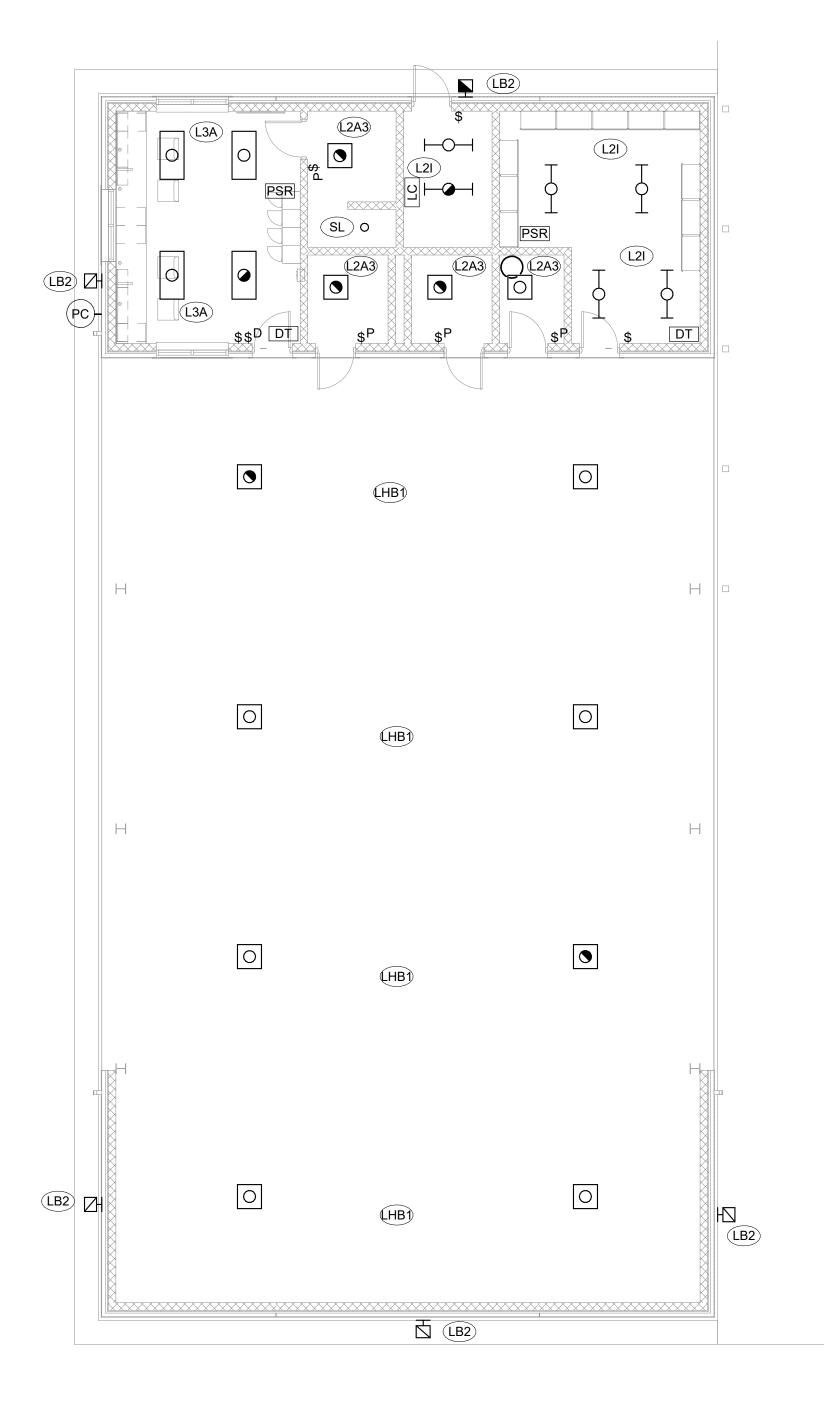
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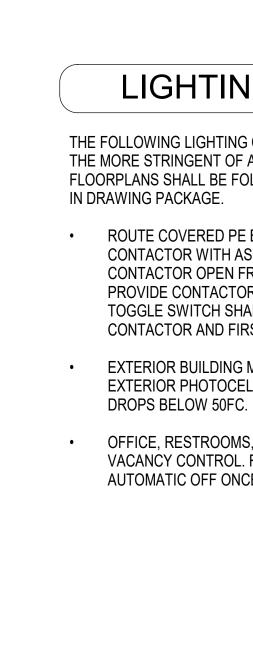
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REMAIN THE PROPERTY OF THE CONSULTANT. THE CONSULTANT SHALL RETAIN ALL COMMON LAW, STATUTORY AND OTHER RESERVED RIGHTS, INCLUDING THE COPYRIGHT THERETO. PURSUANT TO FLORIDA STATUTES, SECTION 558.0035, AN INDIVIDUAL EMPLOYEE OR AGENT MAY NOT BE HELD INDIVIDUALLY LIABLE FOR NEGLIGENCE.	
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ELECTRICAL LIGHTING PLAN 1 SCALE: 1/8" = 1'-0"

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LIGHTING CONTROL NOTES

THE FOLLOWING LIGHTING CONTROLS SHALL APPLY FOR THE FOLLOWING AREAS. THE MORE STRINGENT OF ANY DISCREPANCIES BETWEEN TYPICAL CONTROLS AND FLOORPLANS SHALL BE FOLLOWED. NOTES SHALL APPLY TO ALL LIGHTING PLANS

 ROUTE COVERED PE BUILDING FIXTURES (LHB1) THROUGH LIGHTING CONTACTOR WITH ASTRONOMICAL TIME CLOCK. SCHEDULE SHALL HAVE CONTACTOR OPEN FROM 10PM TO 6AM, AND CLOSED FROM 6AM TO 10PM. PROVIDE CONTACTOR WITH ON/OFF/AUTO SELECTOR SWITCH. ON/OFF TOGGLE SWITCH SHALL BE LOCATED BETWEEN SWITCH LEG FROM CONTACTOR AND FIRST FIXTURE.

• EXTERIOR BUILDING MOUNTED FIXTURES LB2 SHALL BE ROUTED THROUGH EXTERIOR PHOTOCELL SET TO TURN ON FIXTURES WHEN AMBIENT LIGHTING

OFFICE, RESTROOMS, AND STORAGE AREAS SHALL BE PROVIDED WITH VACANCY CONTROL. FIXTURES SHALL BE MANUAL ON TO 100% AND AUTOMATIC OFF ONCE VACANCY IS DETECTED.

DISTRICT for SCHOOL SCHOOL S Ш COUNTY \mathbf{O} Ш \mathbf{X} RED BAY ROSA SANTA б Ш

FL 32563
BREEZE,
- DRIVE, GULF I
HART DR
2535 ELK

REVISIONS:		
No.	Description	Date

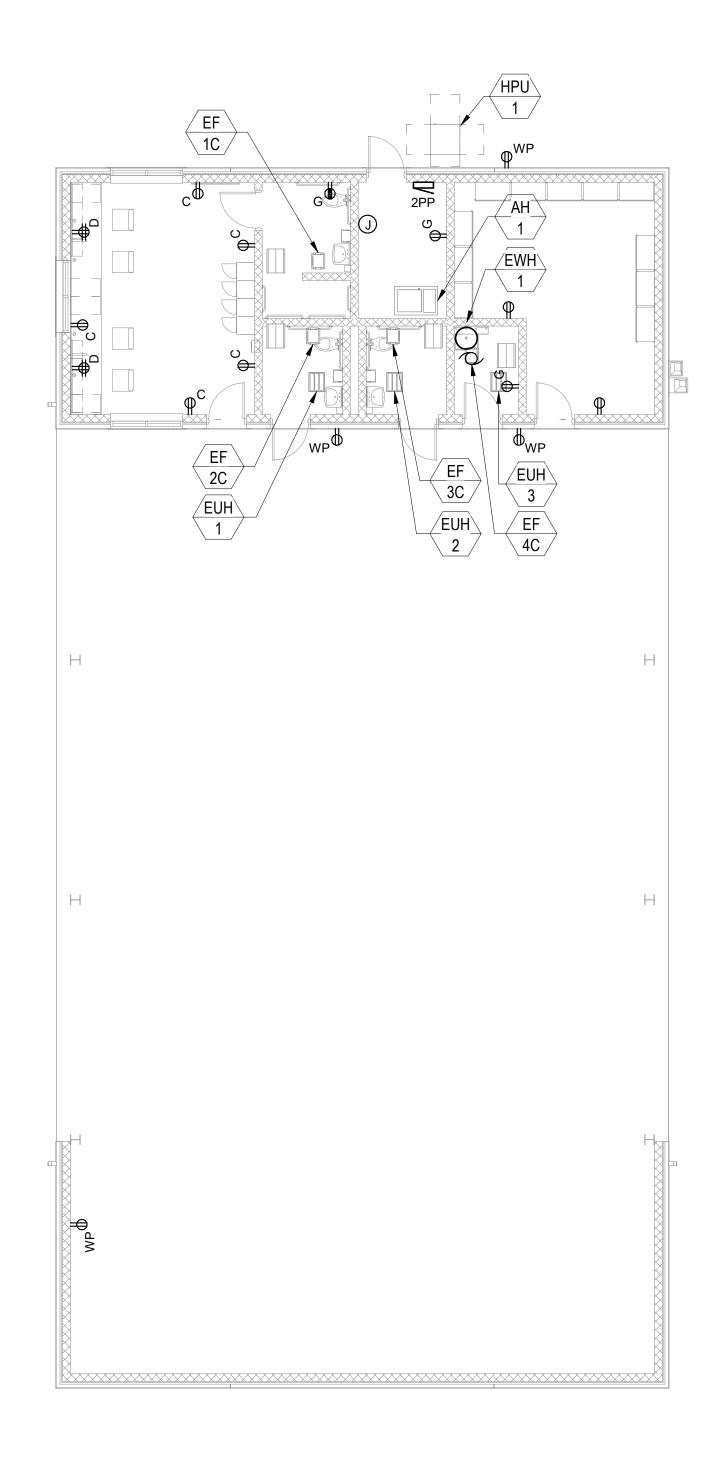
FIRST FLOOR LIGHTING

Project Numbe	er 20055	
Dated	September 29. 2020	
Drawn By	JTH	
Approved By	TAN	
PM	JTH	
E201		

8'	0'	8'	<u>1</u> 6'
SCALE: 1/8	 "=1'-0"		

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DISTRICT for DING 32563 0 SCHOOL ŎIJ Ľ BREEZE, S Μ COUNTY GULF К-8 Ш ш Ŏ RED DRIVI BAY ROSA 2535 ELKHART SANTA O

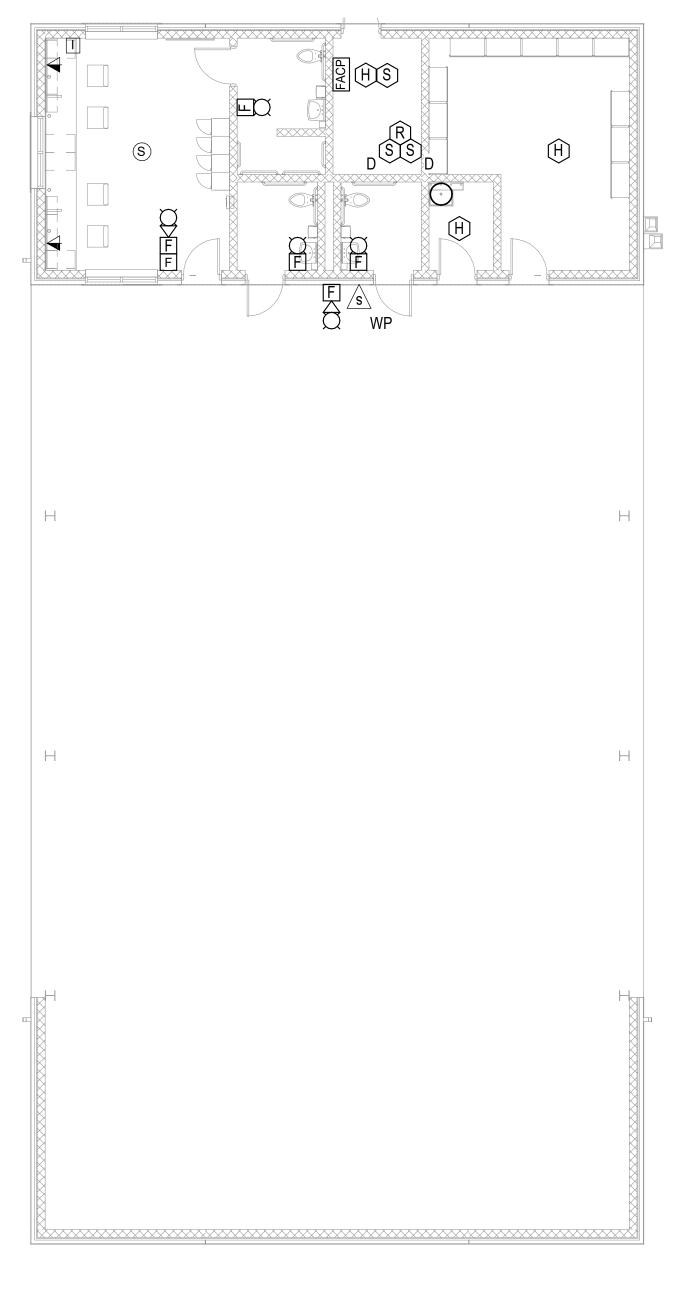
REVISIO	NS:	
No.	Description	Date
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	PLAN		
Project Number	er 20055		
Dated	September 29. 2020		
Drawn By	JTH		
Approved By	TAN		
PM	JTH		
E301			

0'	8'	16'
3"=1'-0"		
	0' 3"=1'-0"	

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REVISIONS:				
Description	Date			
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FIRST FLOOR SYSTEMS PLAN

Project Numb	per 20055			
Dated	September 29. 2020			
Drawn By	JTH			
Approved By	TAN			
PM	JTH			
E401				

8'	0'	8'	1
SCALE: 1/	/8"=1'-0"		