


4065 NORRIS ROAD  
PACE, FL 32571

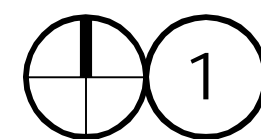

## LOCATION MAP

NOT TO SCALE

**OWNER REPRESENTATIVE:**

Santa Rosa County School Board  
Santa Rosa County, Florida  
Phone: 850-983-5123  
Fax: 850-983-5115

Joseph B. Harrell  
Assistant Superintendent for  
Administrative Services  
Email: harrelj@mail.santarosa.k12.fl.us

**STRUCTURAL ENGINEER:**  
Stephen W. Leonard, PE  
Berube Leonard, LLC  
3101 N 12th Avenue  
Pensacola, FL 32503



NOT FOR  
CONSTRUCTION

STEPHEN W. LEONARD  
FL PE #60370

4065 Norris Road  
Pace, Florida 32571

COVER SHEET AND DRAWING INDEX

[illegible]

SHEET

G001



NOT FOR  
CONSTRUCTION

STEPHEN W. LEONARD  
FL PE #60370

SHEET TITLE:  
EXISTING FOUNDATION & DEMOLITION PLAN

SHEET

# S101





- PRELIMINARY -

NOT FOR  
CONSTRUCTION

- PHASE III REVIEW -

STEPHEN W. LEONARD  
FL PE #60370

PROJECT: SRCSD Pace High School Weight Room Floor Replacement

ADDRESS:

ADDRESS:  
4065 Norris Road  
Pace Florida 3257

**DATE, I**  
**SHEET TITLE.**

SHEET TITLE:  
NEW WORK FOUNDATION PLAN

[illegible]

SHEET

S102

GENERAL NOTES:

1. MATERIALS TO CONFORM TO THE FOLLOWING:

CONCRETE	3,000 PSI AT 28 DAYS
REINFORCING STEEL	ASTM A615 GRADE 60
WELDED WIRE FABRIC	ASTM A185 (FLAT SHEETS)

EPOXY ADHESIVE                      RED HEAD G5+ HIGH STRENGTH EPOXY  
OR APPROVED EQUIVALENT

2. SUB-GRADE PREPARATION IS IN ACCORDANCE WITH THE GEOTECHNICAL ENGINEERING REPORT PREPARED BY TIERRA, INC. REPORT NO. 4511-20-011 DATED MARCH 31, 2020. REFER TO PROJECT SPECIFICATIONS FOR REPORT.

3. EXISTING SUB-GRADE SOILS SHALL BE EXCAVATED TO A DEPTH OF 12 INCHES BELOW THE BOTTOM OF THE SLAB. SOILS AT THIS LEVEL SHALL BE COMPACTED WITH A MECHANICAL PLATE TAMPER TO A MINIMUM SOIL DENSITY OF 95% OF THE MODIFIED PROCTOR TEST (ASTM D1557).

4. BACKFILL SHALL BE THE EXCAVATED SOILS IN 6-INCH THICK MAXIMUM LIFTS EACH COMPACTED TO A MINIMUM SOIL DENSITY OF 95% OF THE MODIFIED PROCTOR TEST (ASTM D1557). PERFORM 5 TESTS PER LIFT; ONE EACH CORNER AND ONE NEAR THE CENTER.


5. SPRAY FINAL GRADE WITH APPROVED TERMITE TREATMENT.

6. ALL ELEVATIONS REFERENCED ON THE STRUCTURAL DRAWINGS ARE ABOVE OR BELOW A FINISHED FLOOR ELEVATION OF +0'-0".

7. FIELD VERIFY ALL EXISTING BUILDING DIMENSIONS SHOWN ON PLANS.

8. PLACE REINFORCING IN CONCRETE WITH A MINIMUM OF 3" CLEAR COVER WHEN CAST AGAINST AND PERMANENTLY EXPOSED TO EARTH. PROVIDE CORNER BARS FOR ALL CONTINUOUS HORIZONTAL REINFORCING.

9. PAINT INTERIOR WALLS IN THE WEIGHT ROOM AREA. MATCH EXISTING SOLID COLORS AND PAINT SCHEME. REFER TO INTERIOR PAINTS AND COATINGS SPECIFICATION SECTION. REPAINTING EXISTING LETTERING AND LOGO ARTWORK NOT REQUIRED.

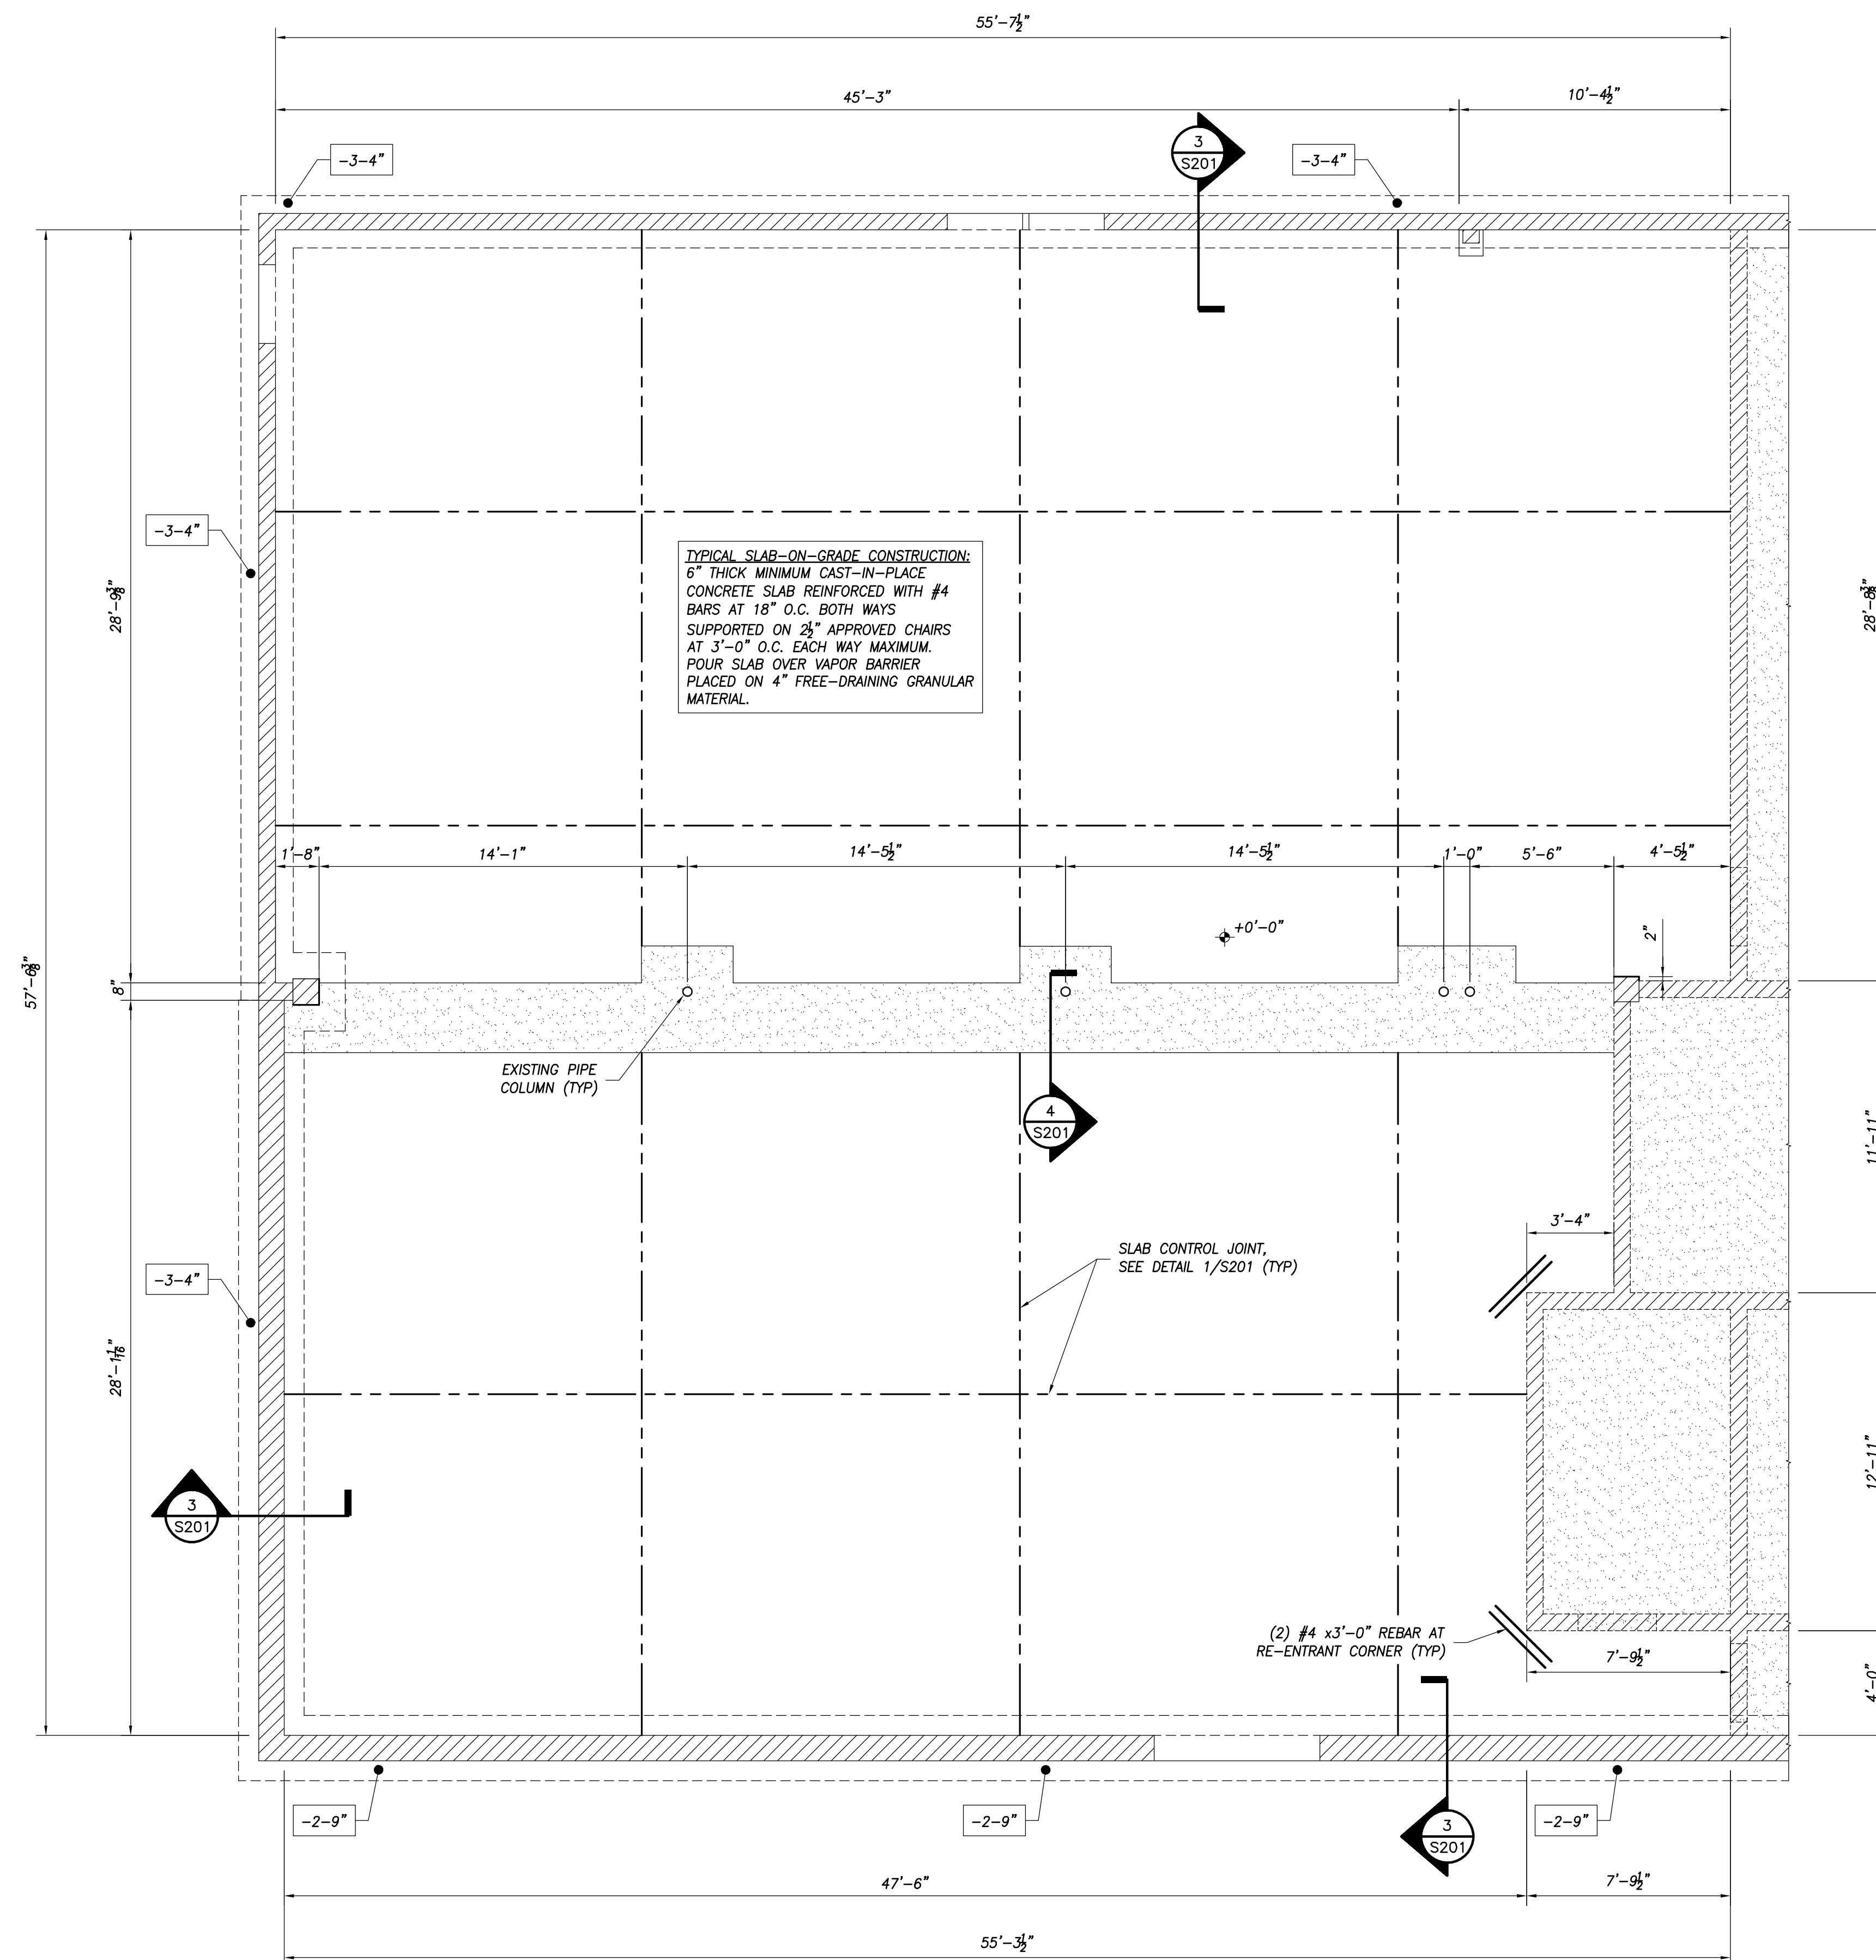

FOUNDATION PLAN NOTES:

SEE SHEET SX FOR GENERAL NOTES AND TYPICAL DETAILS.

— — — — — SLAB CONTROL JOINT (C.J.) SEE TYPICAL DETAIL

$-2'-0"$  —● TOP OF FOOTING (U.N.O.) SEE PLAN (FIELD VERIFY)



NEW FOUNDATION PLAN

SCALE 1/4" = 1'-0"





STEPHEN W. LEONARD  
FL PE #60370

PROJECT: SARCSD Pace High School Weight Room Floor Replacement	ADDRESS: 4065 Norris Road Pace, Florida 32571	SHEET TITLE: INTERIOR ELEVATION, SECTIONS AND DETAILS
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[illegible]

SHEET

**S201**

